



PROPOSED FRONT ELEVATION
 SCALE: 1/4" = 1'-0"

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PROJECT INFORMATION	
THE PROJECT INVOLVES THE CONSTRUCTION OF A NEW SINGLE FAMILY, TWO STORY FRAME DWELLING.	
NUMBER OF BEDROOMS:	EXISTING: 0 PROPOSED: 4
AREA OF LARGEST FLOOR:	1,941 Sq. Ft.
OCCUPANCY: 1 PER 200 Sq. Ft.	
FIRST FLOOR:	1,941 Sq. Ft. 1,941 / 200 = 9
SECOND FLOOR:	972 Sq. Ft. 972 / 200 = 4
TOTAL OCCUPANCY:	13 OCCUPANTS

- LIST OF CODES:**
- 2021 INTERNATIONAL BUILDING CODE, NJ EDITION
 - 2021 INTERNATIONAL RESIDENTIAL CODE, NJ EDITION
 - 2021 INTERNATIONAL MECHANICAL CODE
 - 2020 NATIONAL ELECTRIC CODE
 - 2021 INTERNATIONAL FIRE CODE
 - 2021 I.E.C.C. NJ EDITION (RESIDENTIAL)
 - 2021 NATIONAL STANDARD PLUMBING CODE
 - 2021 INTERNATIONAL FUEL GAS CODE
 - UCC NEW JERSEY REHABILITATION SUBCODE NJAC 5:23-6

CONSTRUCTION DATA	
CONSTRUCTION TYPE:	5B
CONSTRUCTION CLASS:	III
USE GROUP:	R-5
CONSTRUCTION VOLUME:	61,316 Cu. Ft.
FIRST FLOOR AREA:	1,941 Sq. Ft.
SECOND FLOOR AREA:	972 Sq. Ft.
TOTAL LIVING AREA:	2,913 Sq. Ft.
LAND AREA DISTURBED:	3,609 Sq. Ft.
BUILDING HEIGHT:	31'10 1/2"

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 PHONE: 973-998-4979
 EMAIL: BABULA.ARCHITECTURE@GMAIL.COM

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 Fine Hill Farms Development LLC
 MODEL-B
 MILFORD, PA 18337


NEW JERSEY REGISTERED ARCHITECTS
 SCOTT WILHELM & RAISEL SAUL

Drawn By: JB
 Job No: 22-095
 Date: 5-15-24
 Sheet No: 1 of 12
 Sheet: A1.0

Pine Hill Farms Model-B



PROPOSED LEFT SIDE ELEVATION
SCALE: 1/4" = 1'-0"

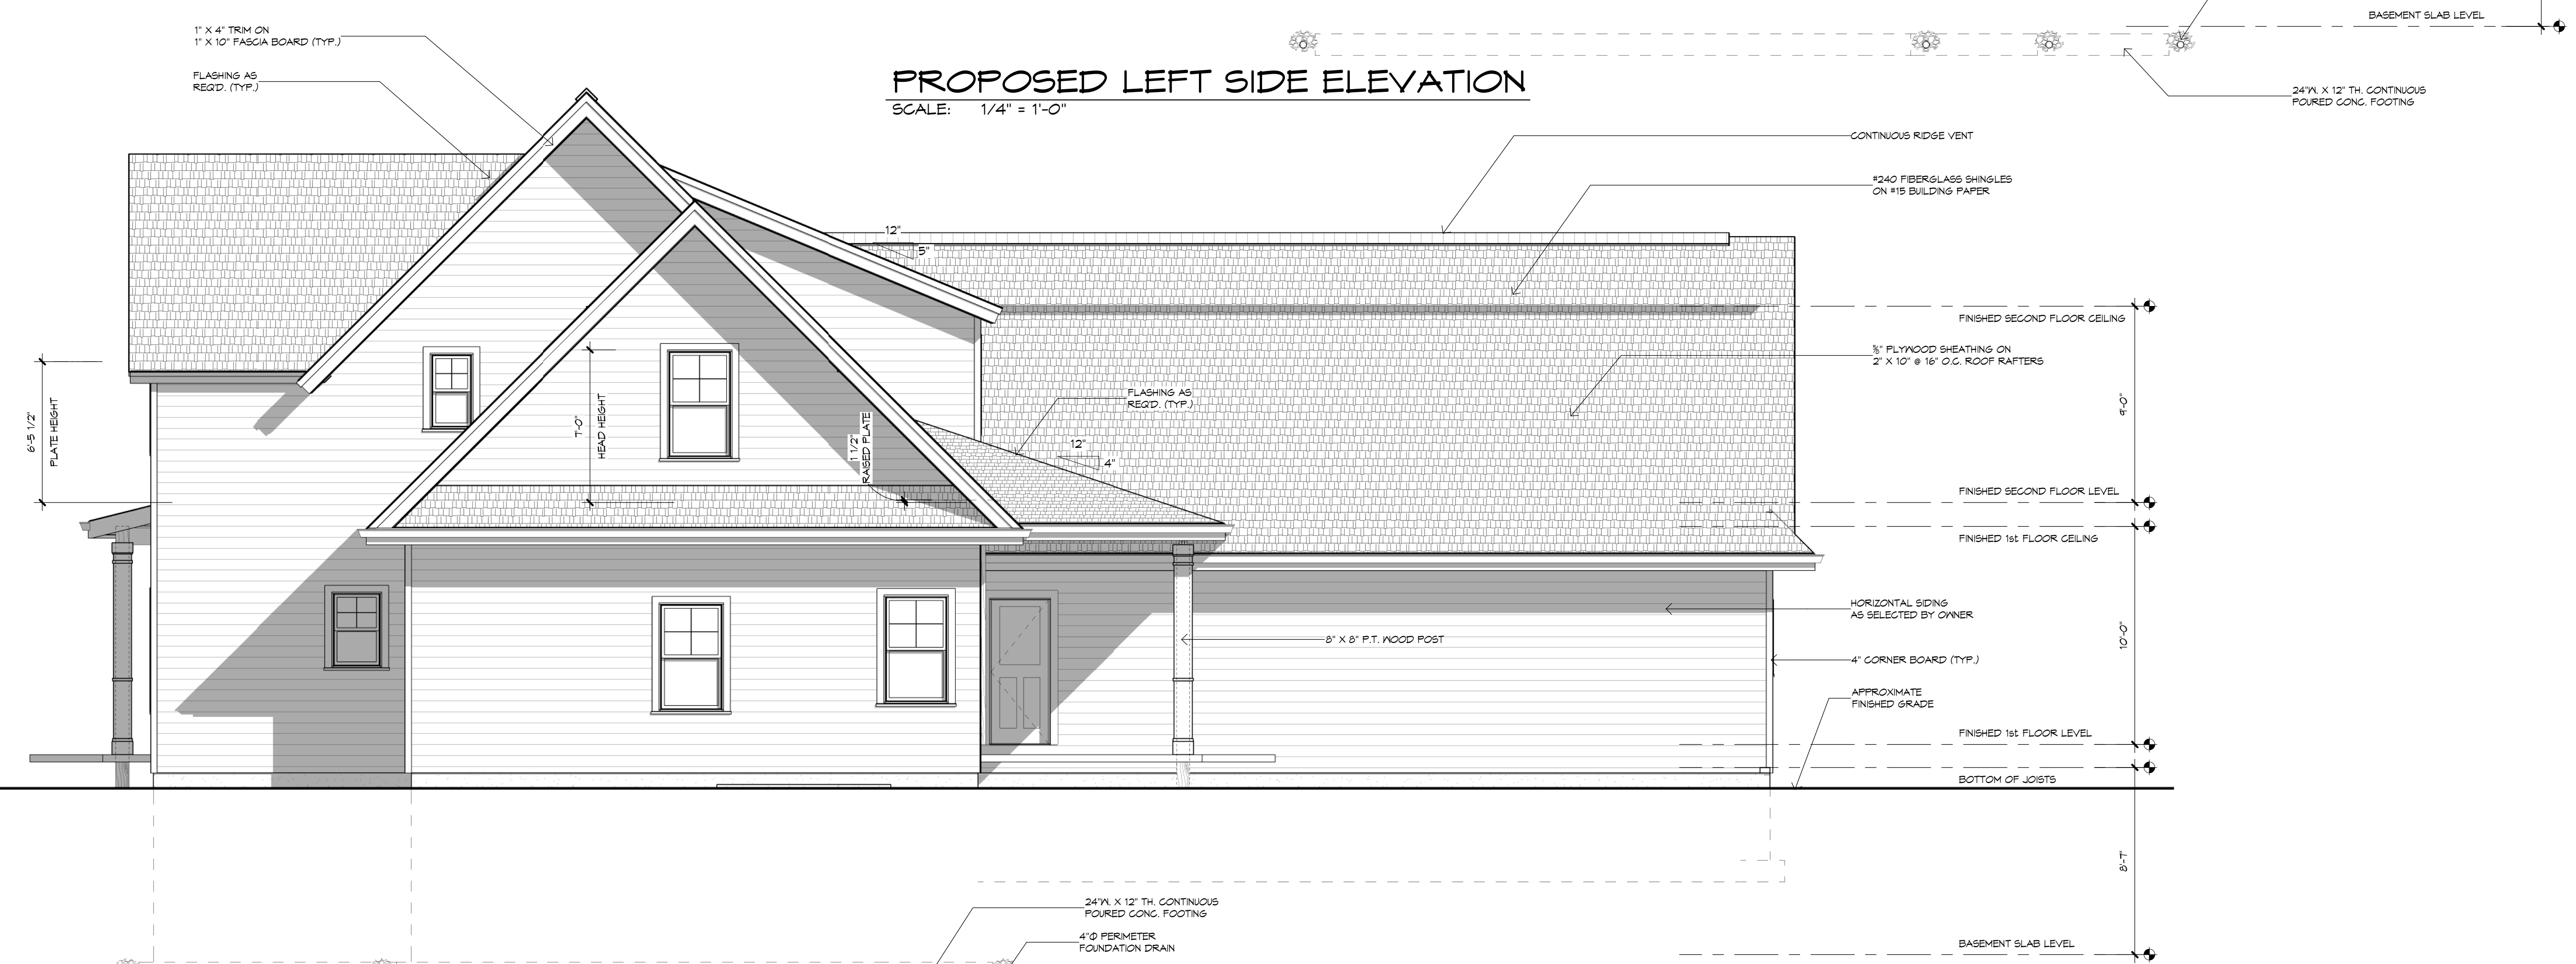

PROPOSED RIGHT SIDE ELEVATION
SCALE: 1/4" = 1'-0"

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Block: 0 Lot: 0

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BABULA ARCHITECTURE LLC
Pine Hill Farms Development LLC
MODEL-B
MILFORD, PA 18337

Drawn By: JB
Date: 22-095
Sheet No: 5-15-24
2 of 12
Sheet: A1.1



PROPOSED REAR ELEVATION
SCALE: 1/4" = 1'-0"



Project 22-095 Pine Hill Farms Model-B
 Energy Code: 2018 IECC
 Location: Pike County, Pennsylvania
 Construction Type: Single-family
 Project Type: New Construction
 Conditioned Floor Area: 2,898 ft²
 Glazing Area: 10%
 Climate Zone: 5 (6499 HDD)
 Permit Number:
 Construction Site: Milford, PA 18337
 Owner/Agent:
 Designer/Contractor:

Compliance: Passes using UA trade-off
 Compliance: 3.0% Better Than Code Maximum UA: 399 Your UA: 387
 The % Better or Worse Than Code Index reflects how close to compliance the house is based on code trade-off rules. It DOES NOT provide an estimate of energy use or cost relative to a minimum-code home.
 Slab-on-grade tradeoffs are no longer considered in the UA or performance compliance path in REScheck. Each slab-on-grade assembly in the specified climate zone must meet the minimum energy code insulation R-value and depth requirements.

Envelope Assemblies

Assembly	Gross Area of Perimeter	Cavity R-Value	Cont. R-Value	Prop. U-Factor	Req. U-Factor	Prop. UA	Req. UA
Ceiling: Flat Ceiling or Scissor Truss	1,864	38.0	0.0	0.030	0.026	56	48
Wall: Wood Frame, 16" o.c.	3,309	21.0	0.0	0.057	0.060	167	176
Door: Solid Door (under 50% glazing)	61			0.270	0.300	16	18
Door 1: Glass Door (over 50% glazing)	84			0.270	0.300	23	25
Window: Vinyl Frame	230			0.270	0.300	62	69
Floor: All-Wood Joist/Truss	30	38.0	10.0	0.021	0.033	1	1
Floor 1: All-Wood Joist/Truss	1,864	30.0	0.0	0.033	0.033	62	62

Compliance Statement: The proposed building design described here is consistent with the building plans, specifications, and other calculations submitted with the permit application. The proposed building has been designed to meet the 2018 IECC requirements in REScheck Version: REScheck-Web and to comply with the mandatory requirements listed in the REScheck Inspection Checklist.

Name - Title Signature Date

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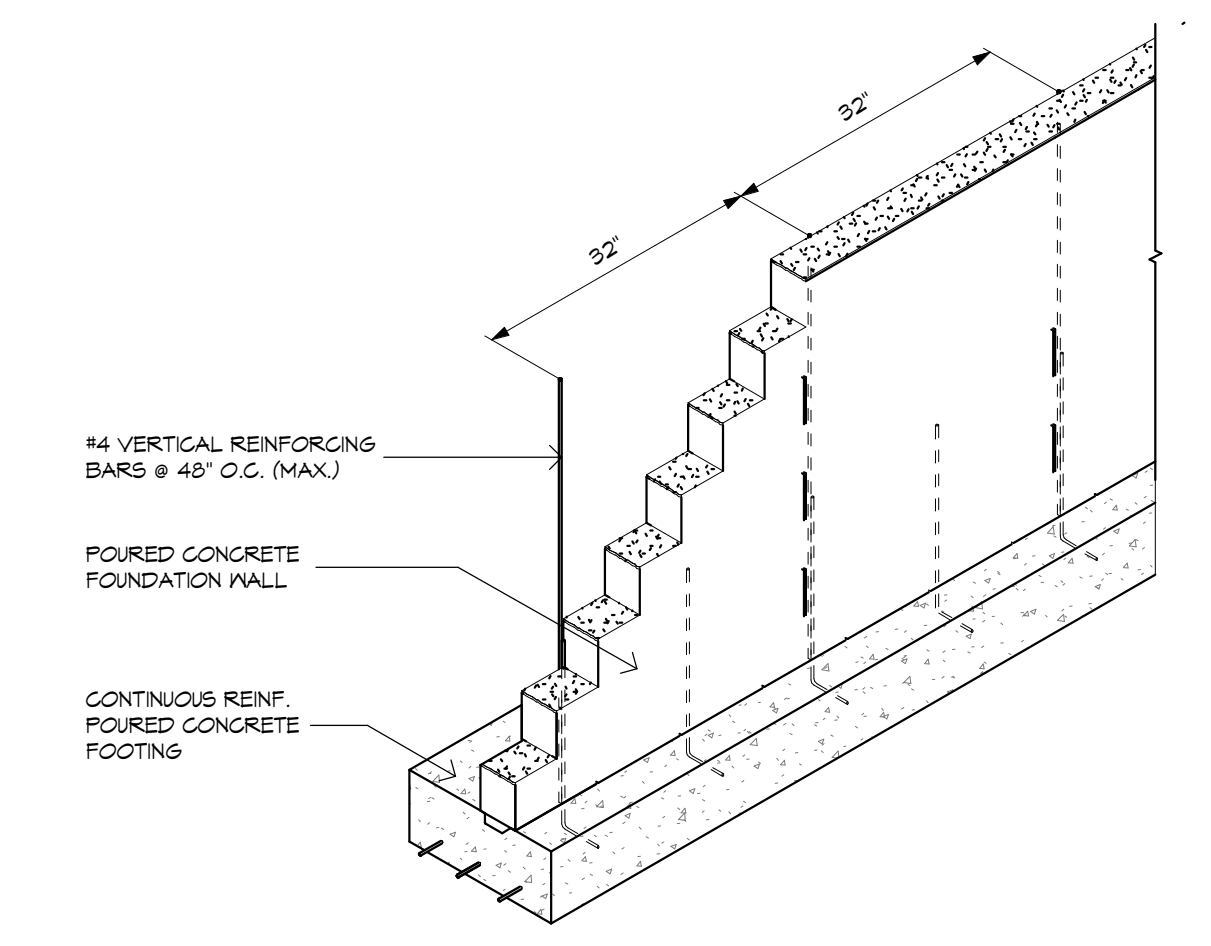
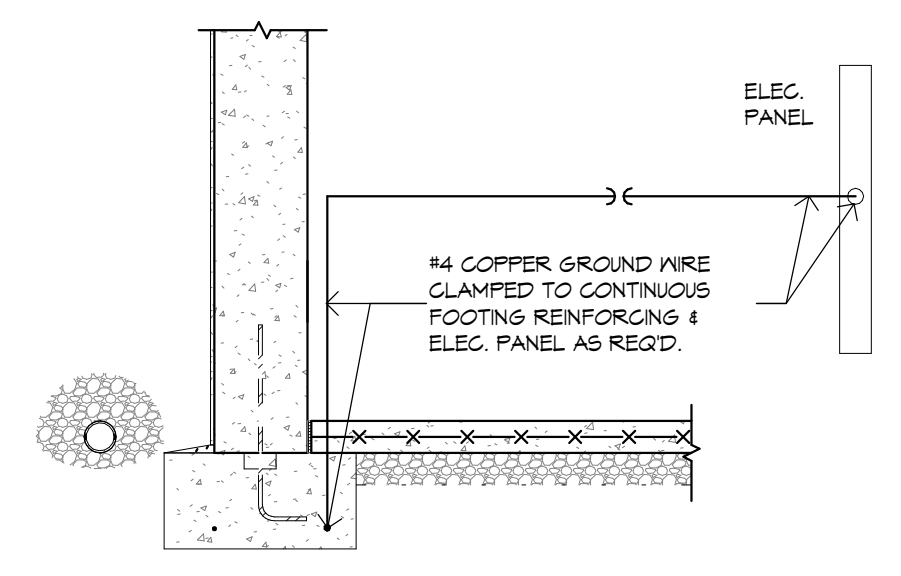
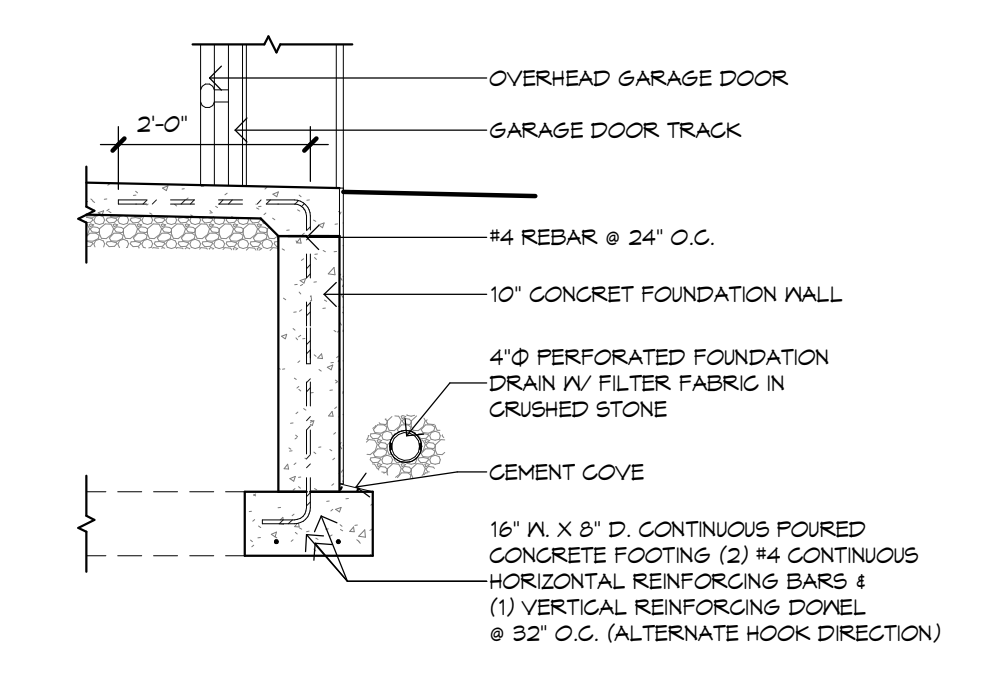
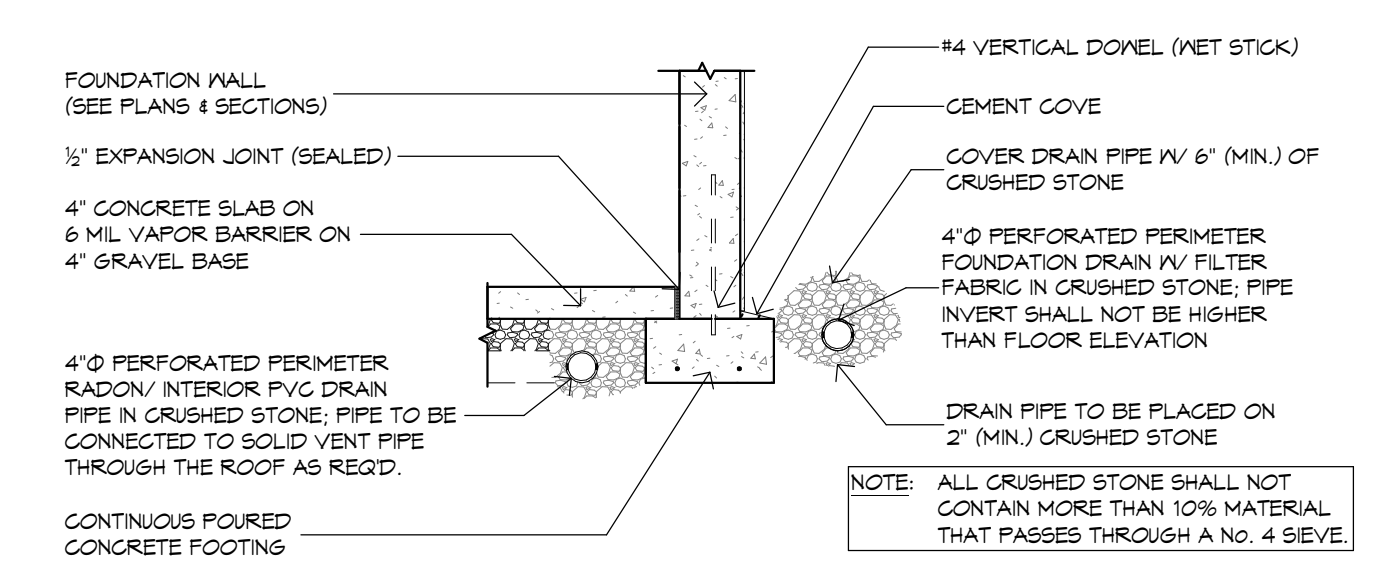
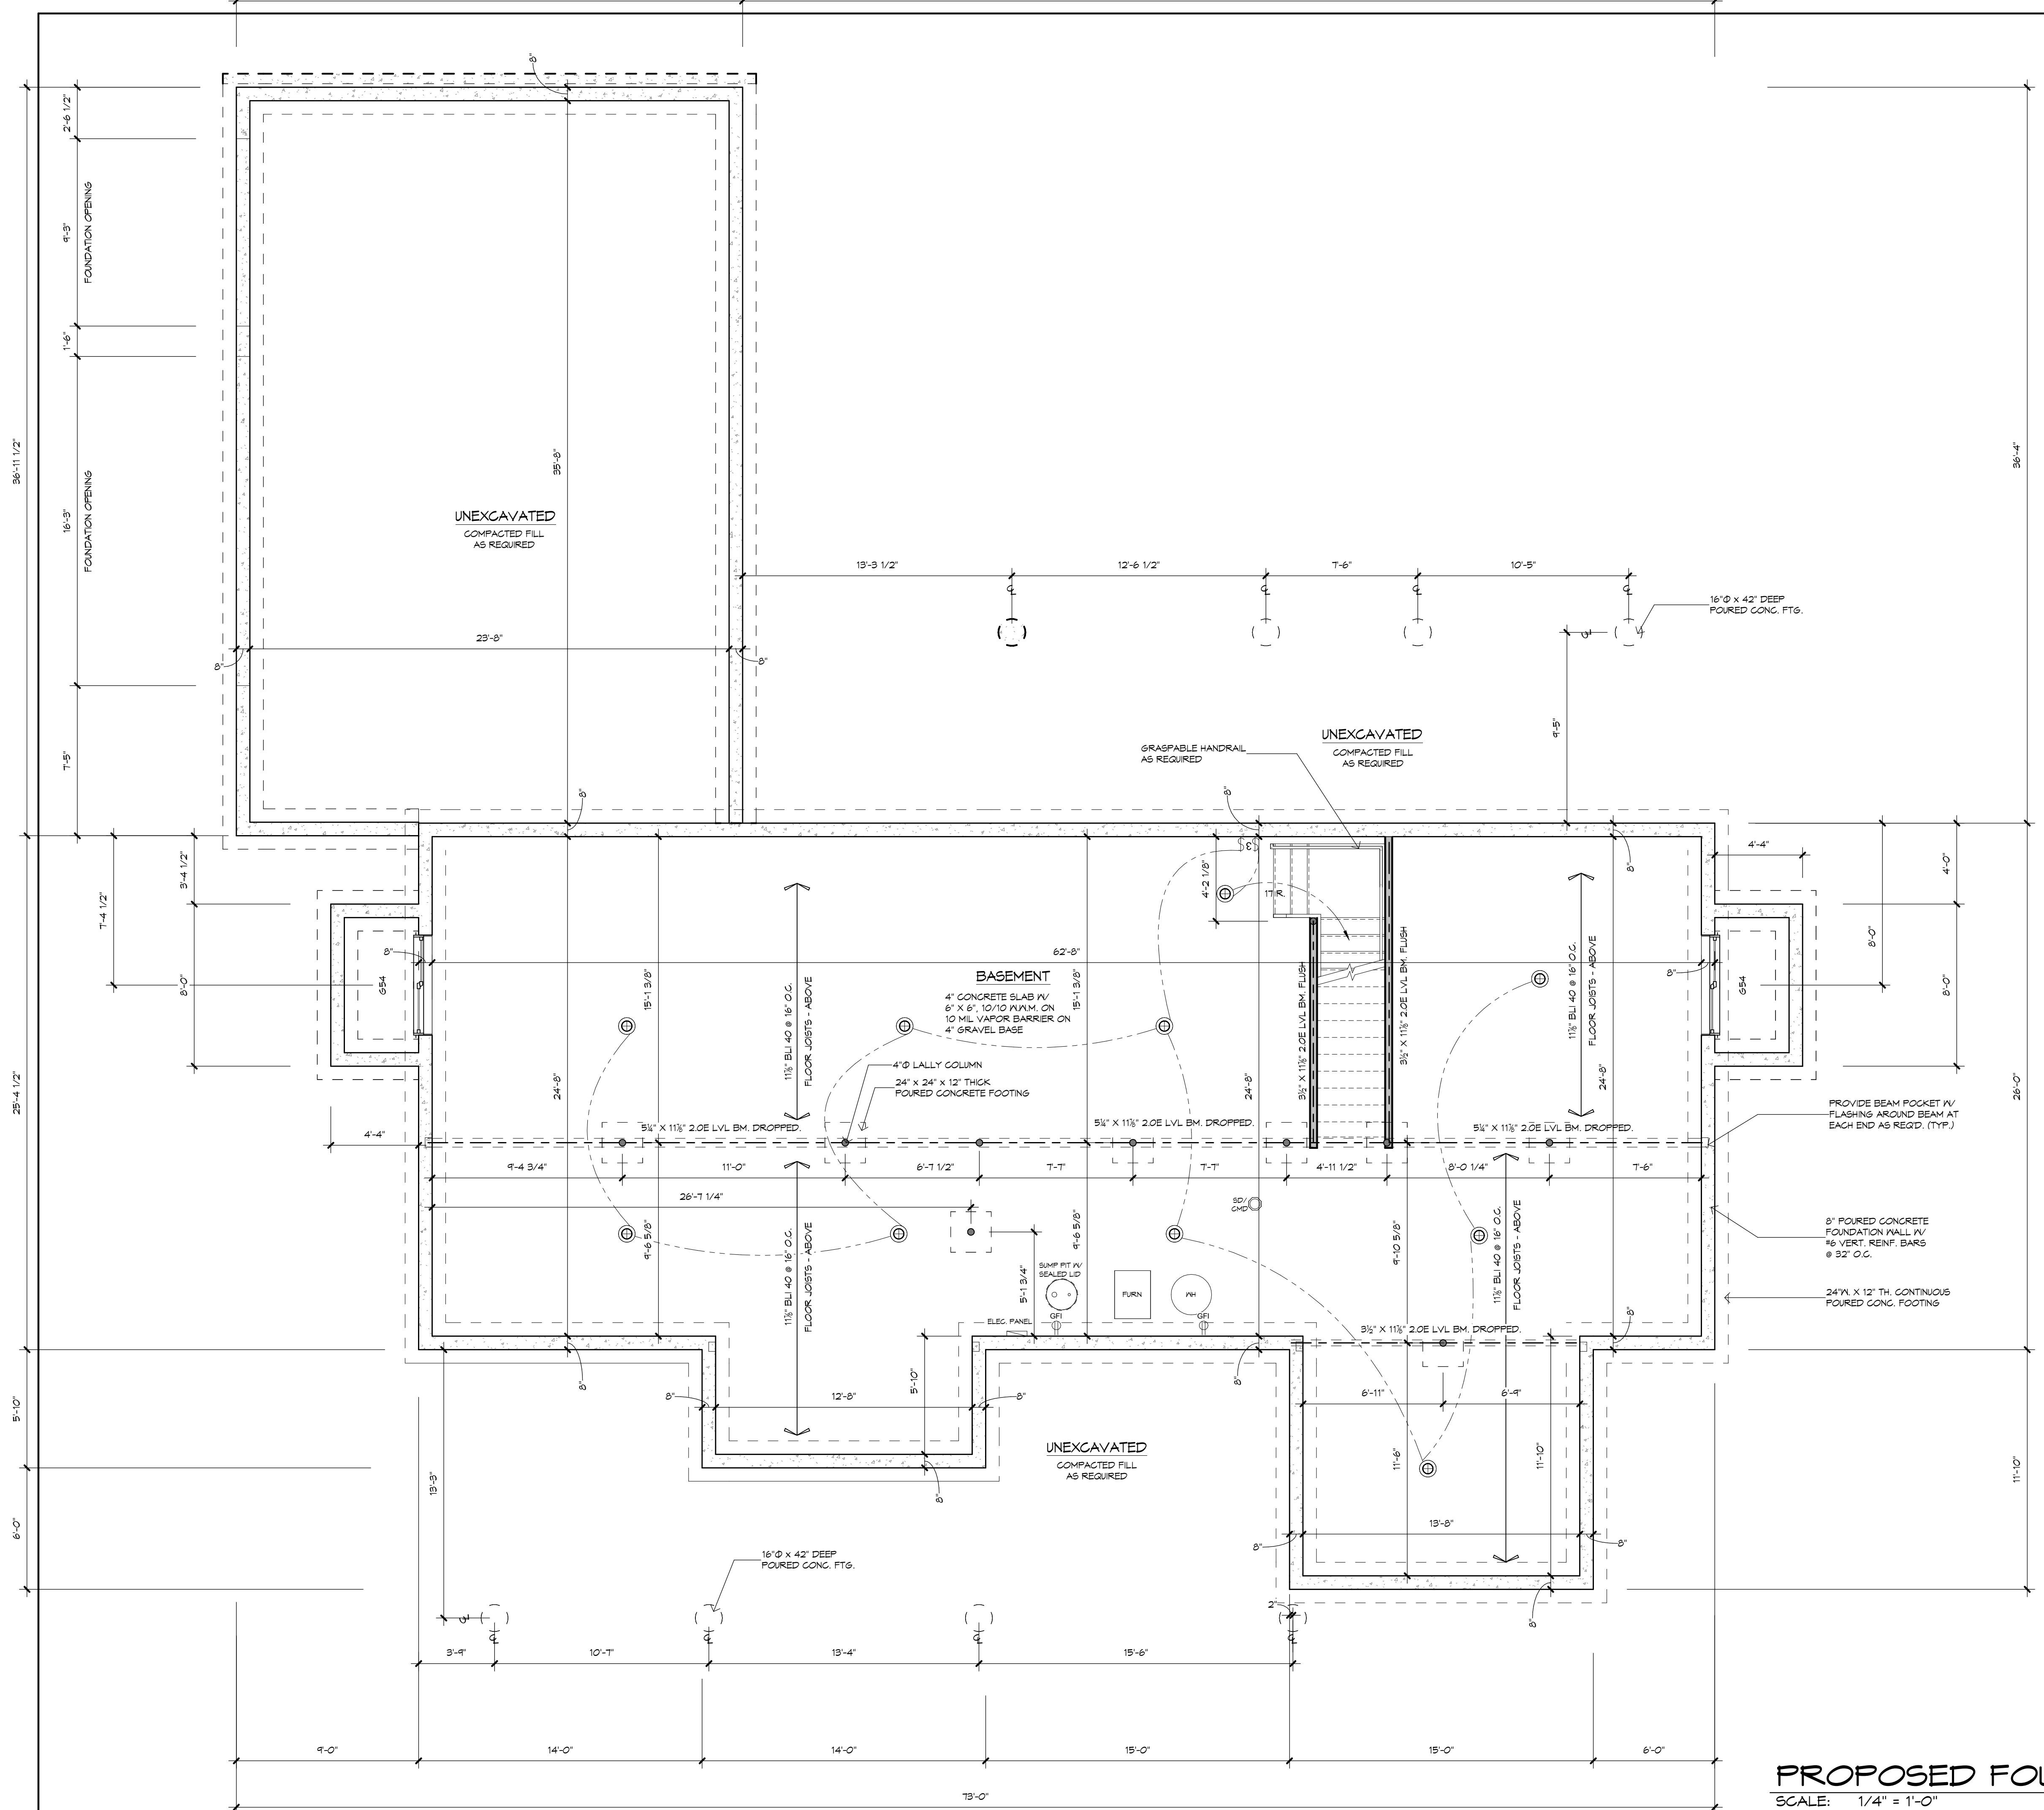
REVISIONS

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 Drawn By: JB
 Job No: 22-095
 Date: 5-15-24
 Sheet No: 3 of 12
 Sheet: A1.2



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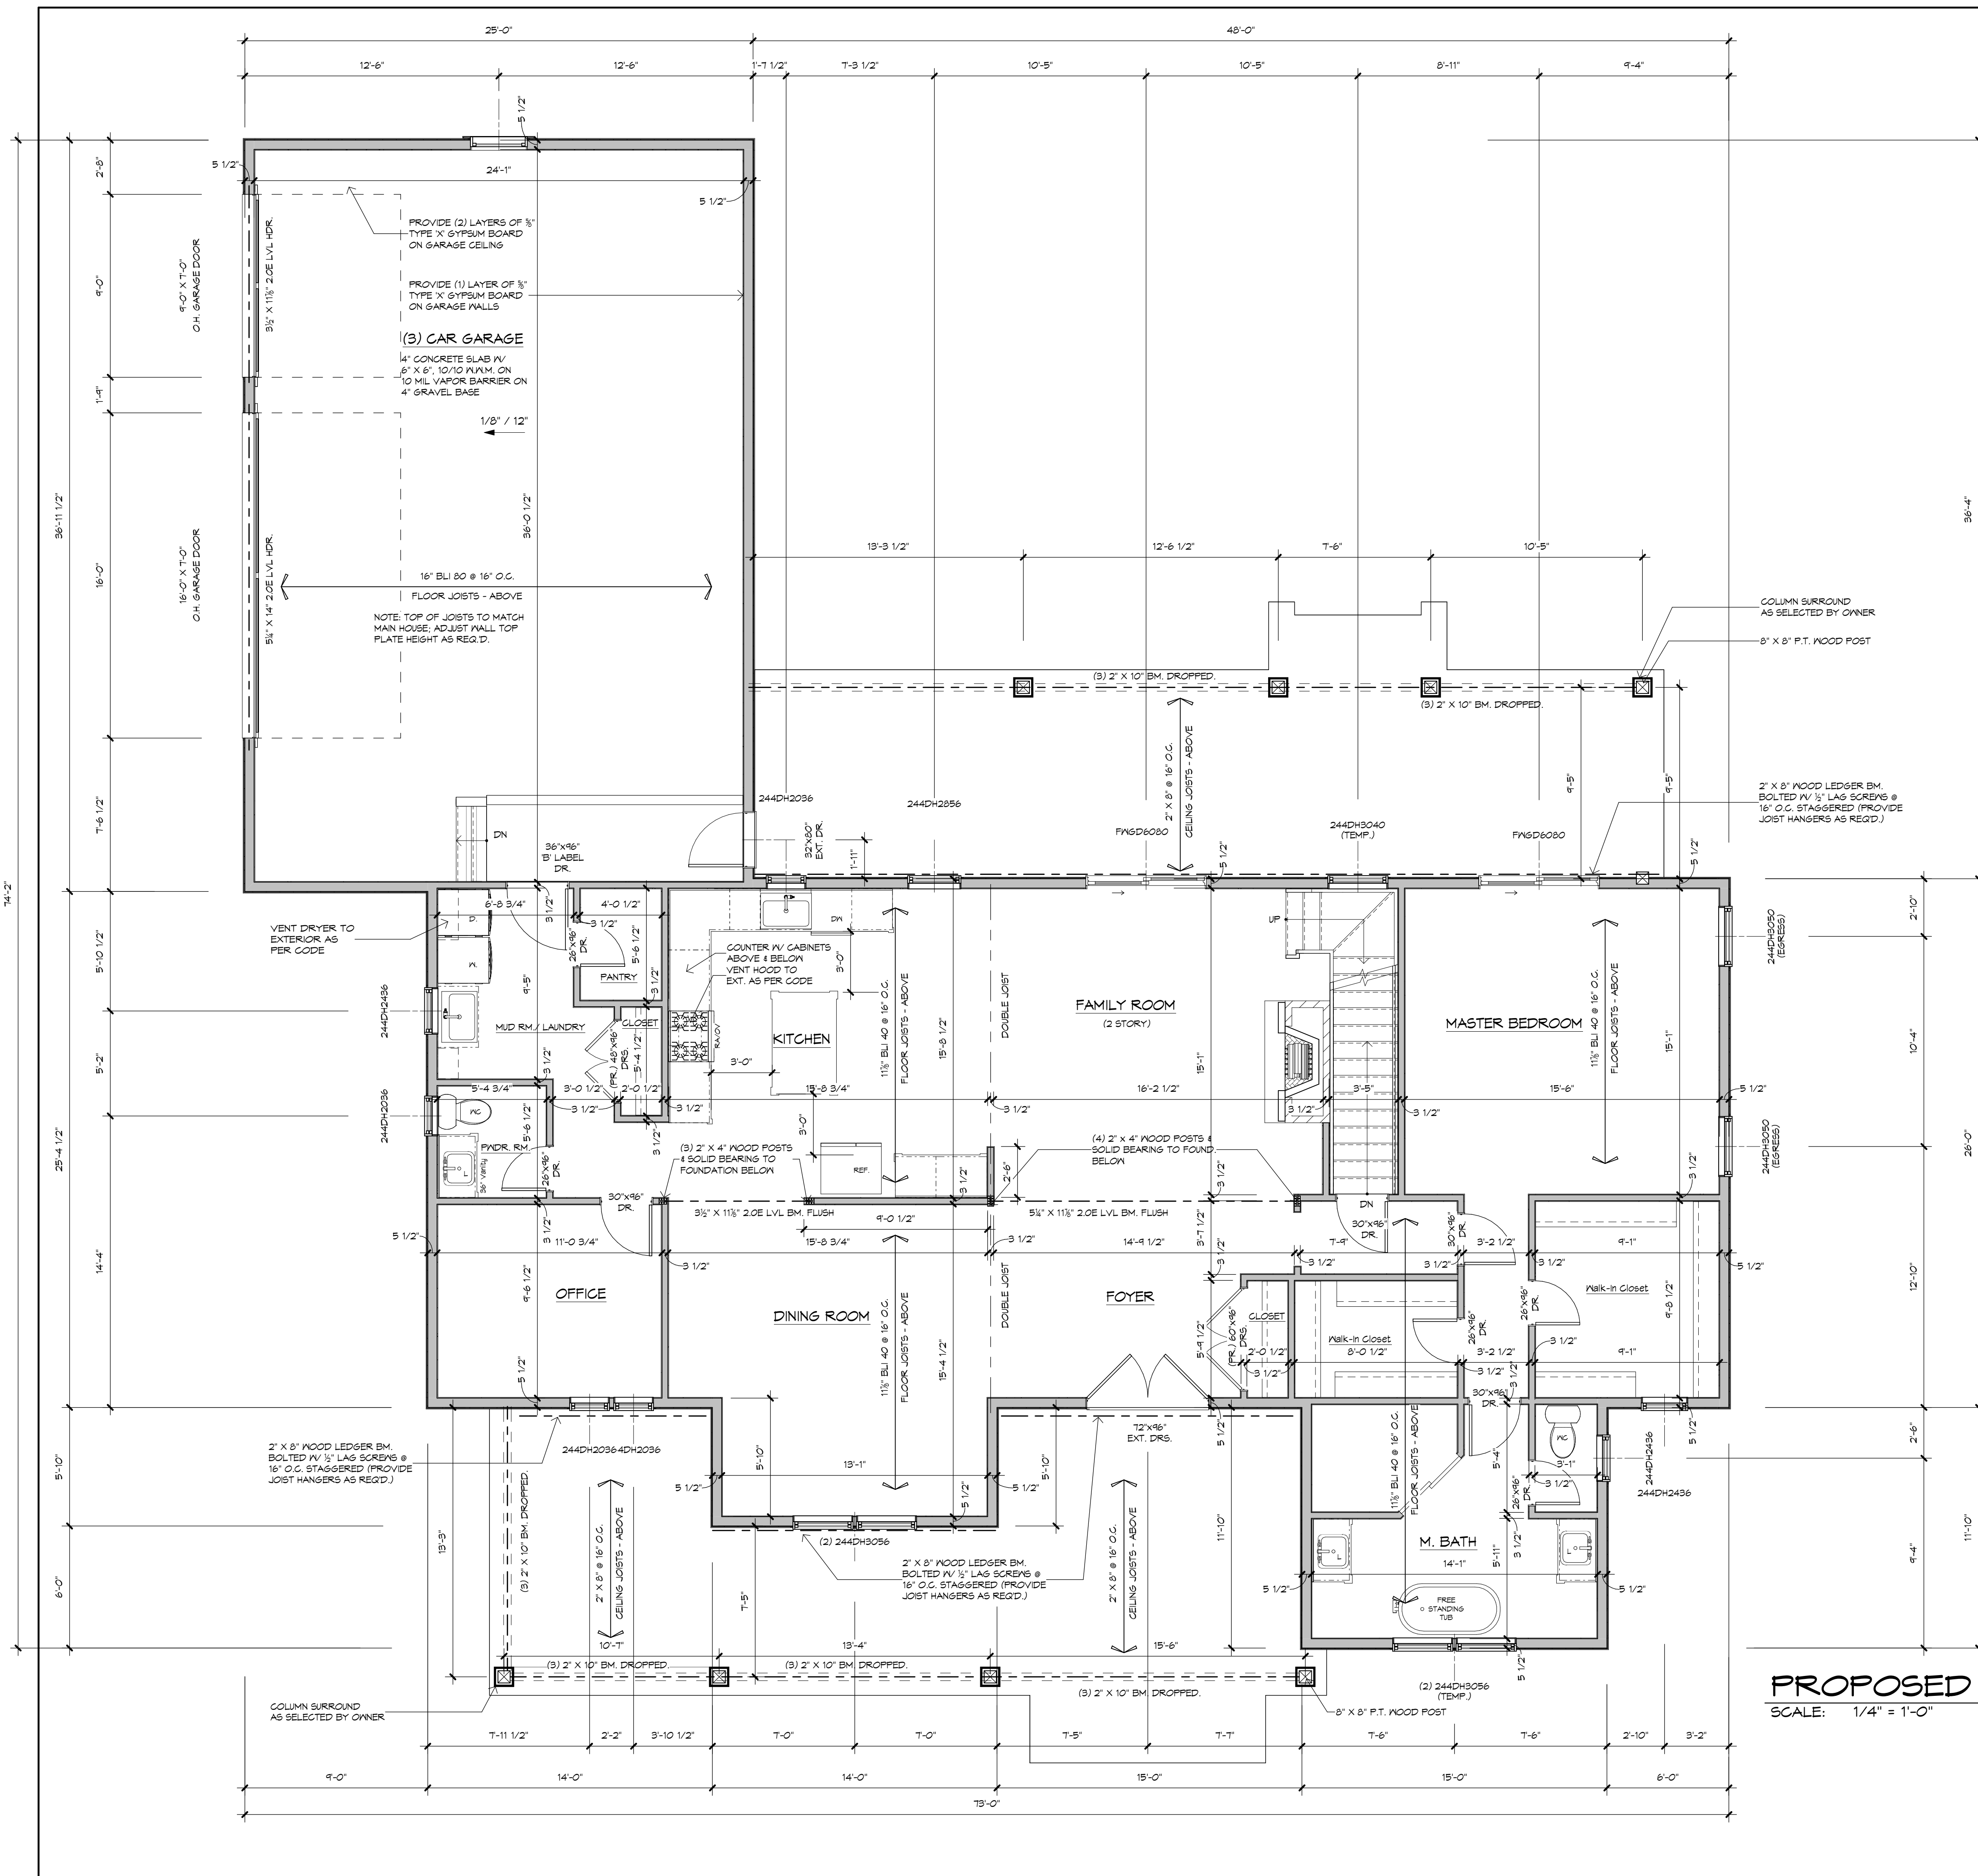
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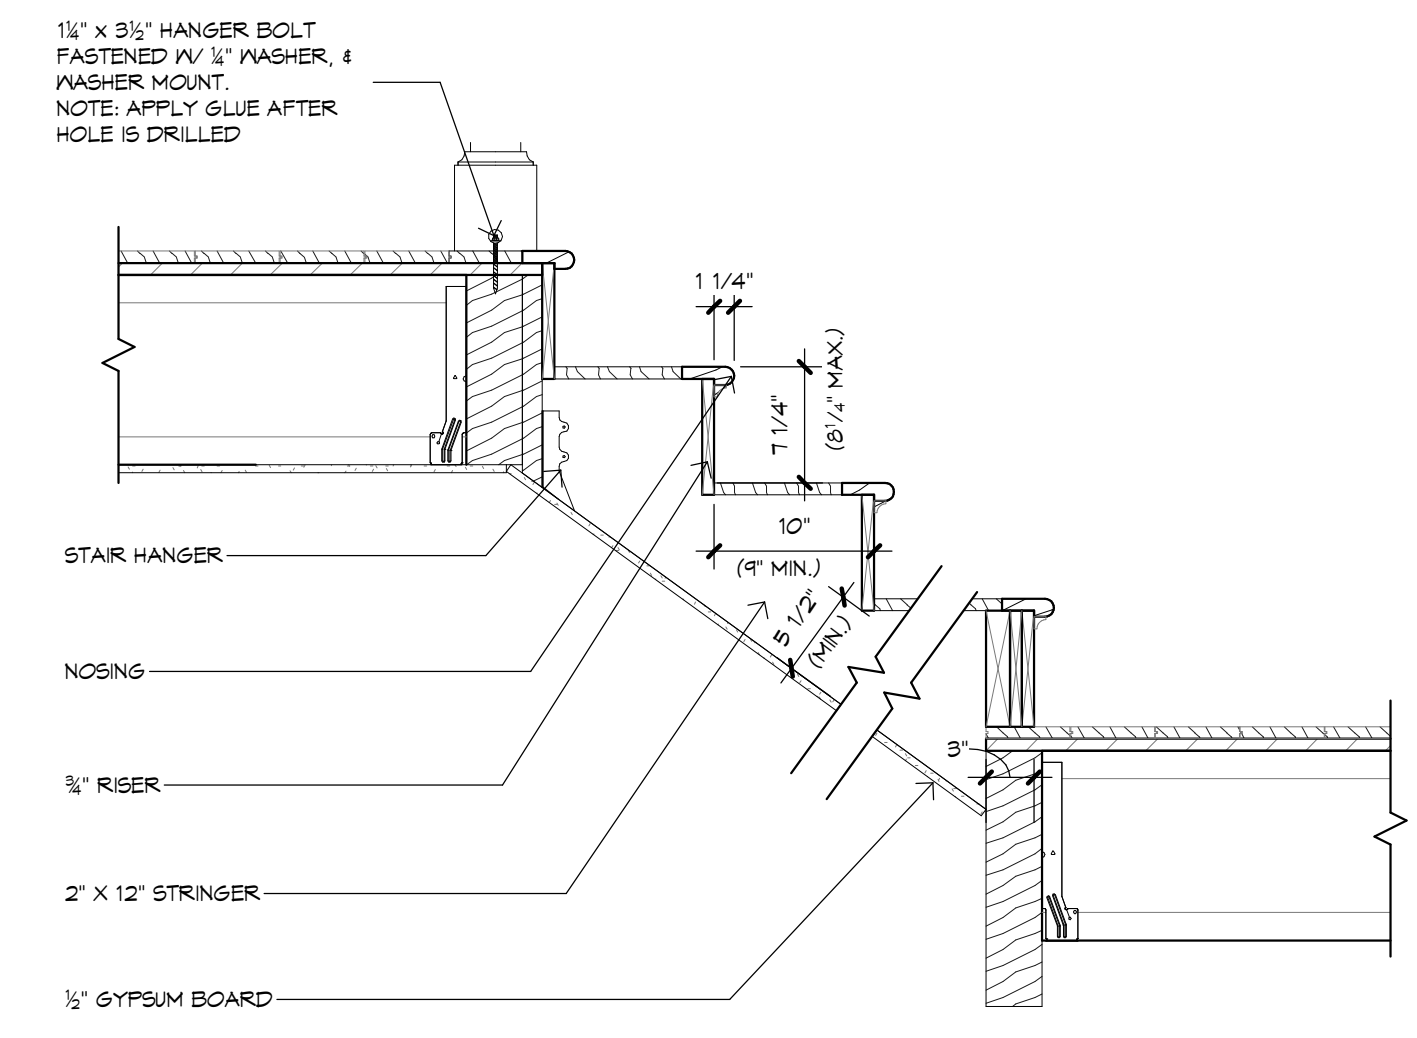
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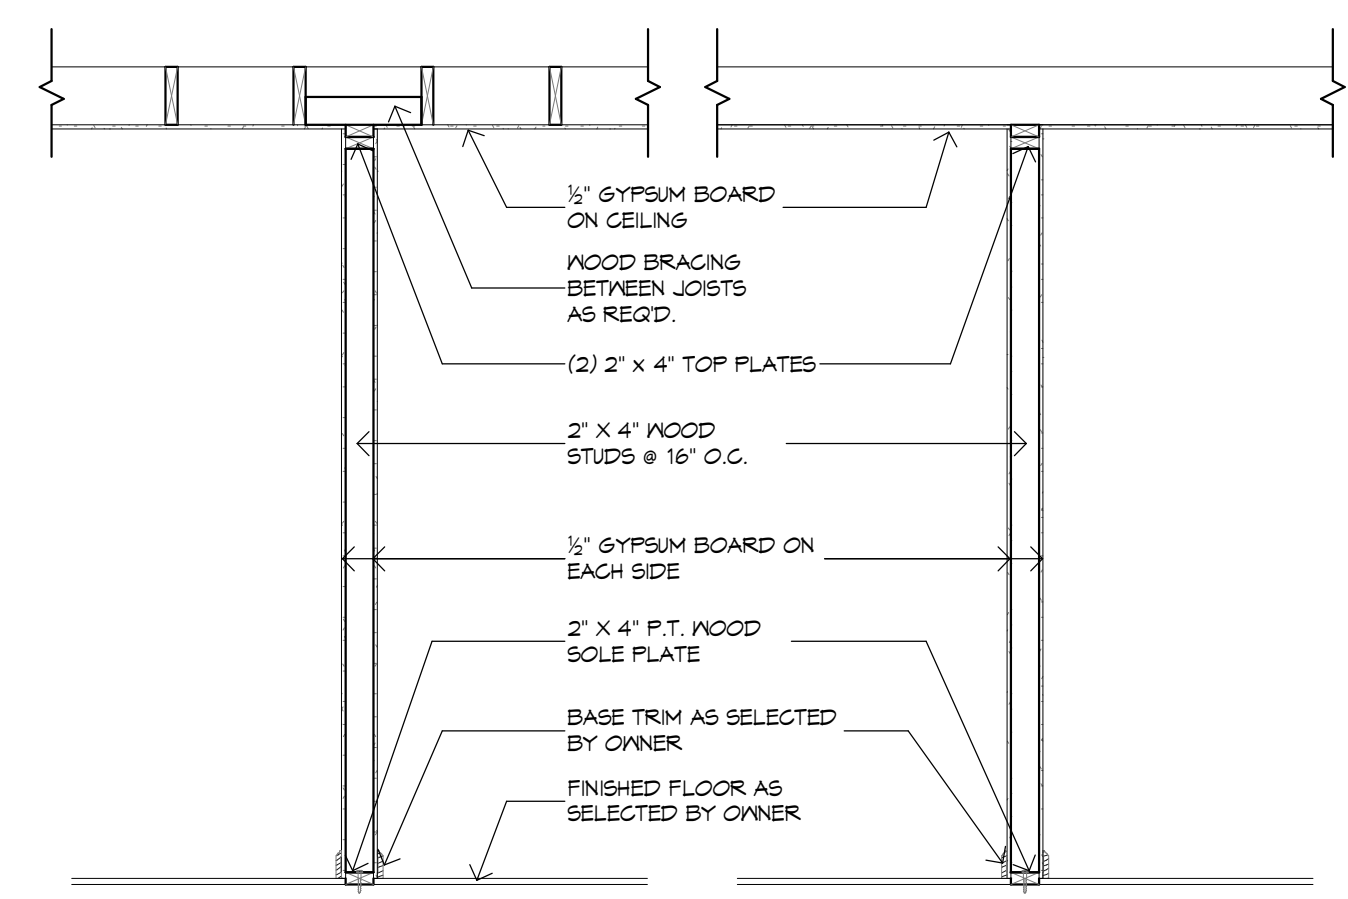
Drawn By: JB
Date: 22-095
Date: 5-15-24
Sheet No: 4 of 12
Sheet: A2.0




PROPOSED FIRST FLOOR PLAN
SCALE: 1/4" = 1'-0"



STAIR DETAIL
SCALE: 1" = 1'-0"



TYPICAL INTERIOR WALL PARTITION
SCALE: 1/2" = 1'-0"

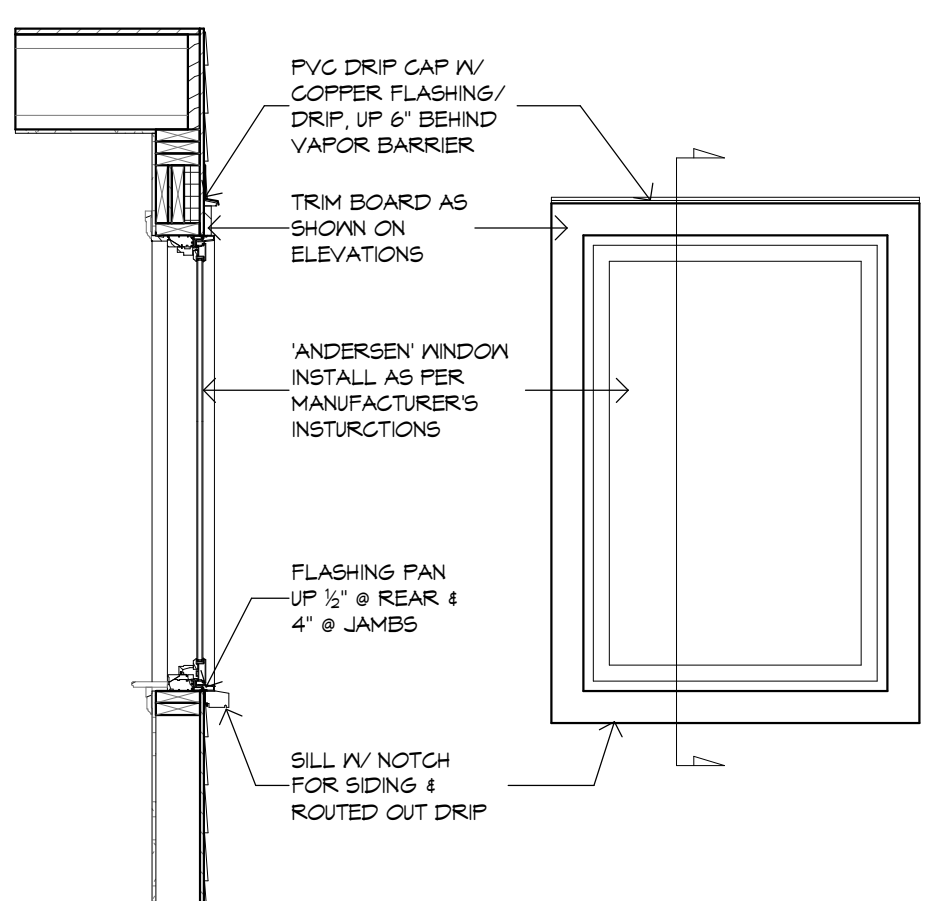

WINDOW DETAIL
SCALE: 1/2" = 1'-0"

LIVING SPACE	
PROPOSED FIRST FLOOR:	PROPOSED 1,941 Sq. Ft.
PROPOSED SECOND FLOOR:	972 Sq. Ft.
TOTAL LIVING SPACE:	2,913 Sq. Ft.
GARAGE:	896 Sq. Ft.


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 MODEL-B
 MILFORD, PA 18337
 Job No: 22-095
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 Sheet: **A2.1**

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PROPOSED SECOND FLOOR PLAN
 SCALE: 1/4" = 1'-0"

LIVING SPACE

PROPOSED FIRST FLOOR:	1,941 Sq. Ft.
PROPOSED SECOND FLOOR:	972 Sq. Ft.
TOTAL LIVING SPACE:	2,913 Sq. Ft.
GARAGE:	896 Sq. Ft.

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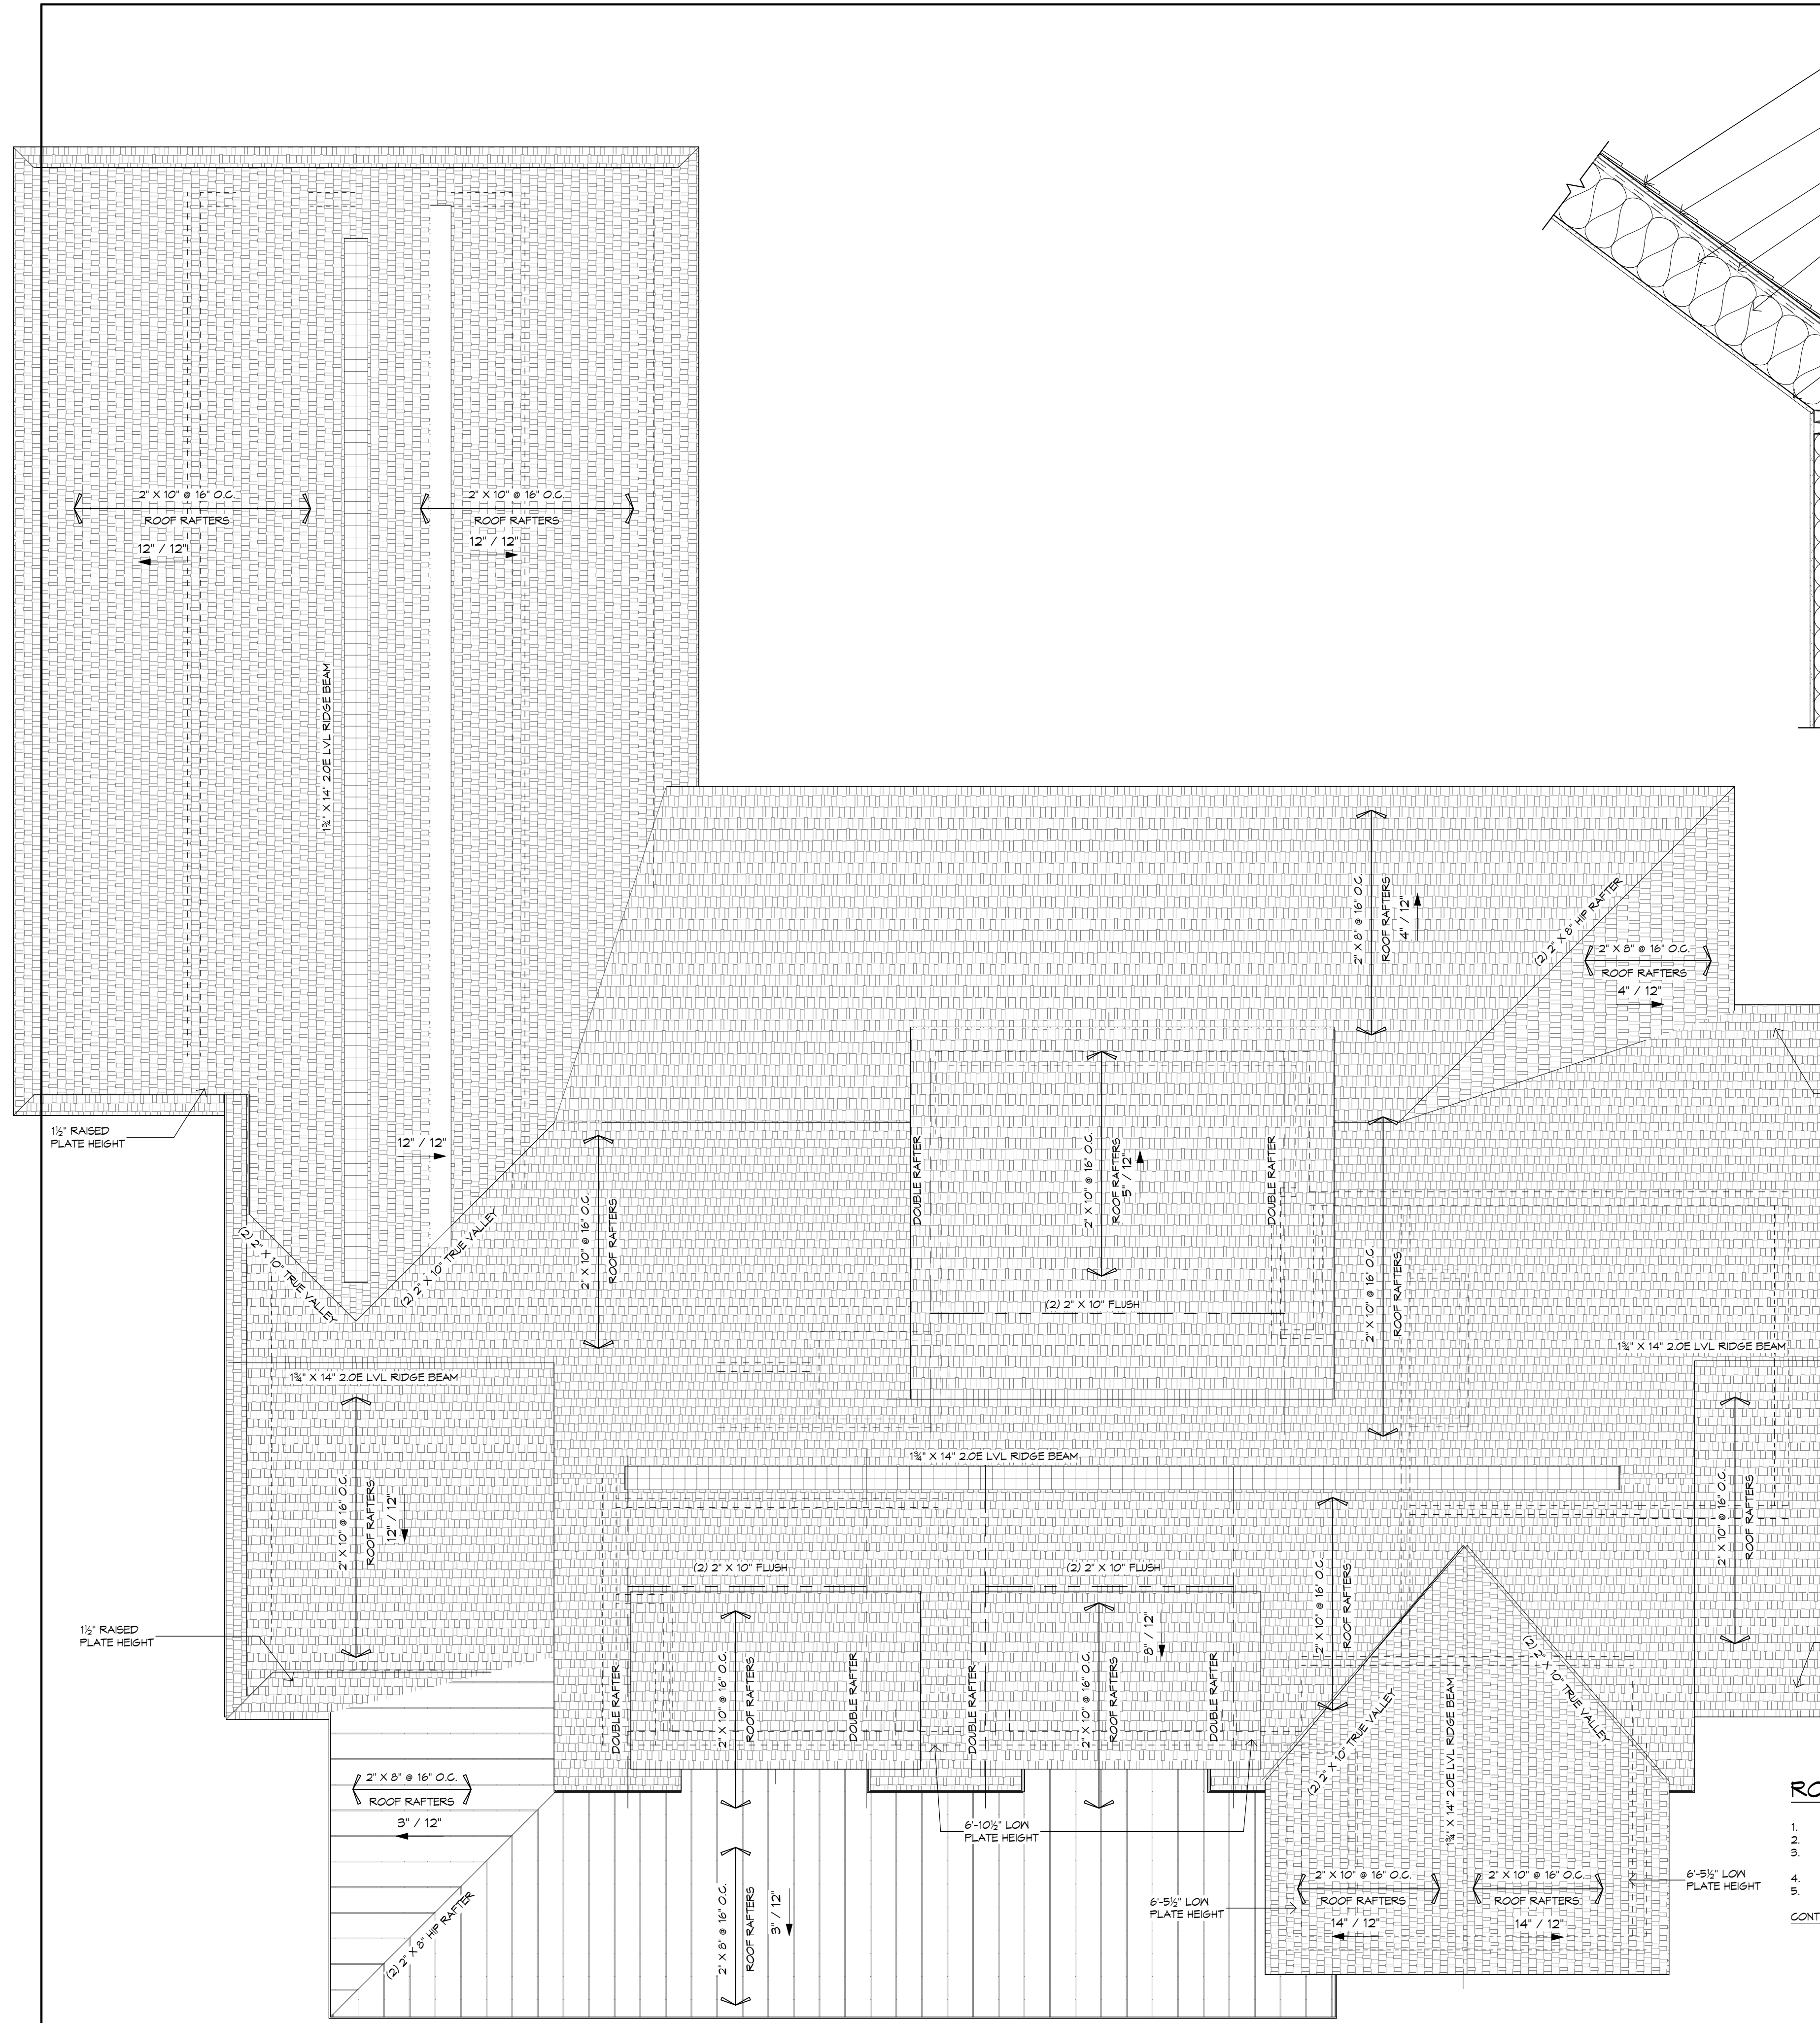
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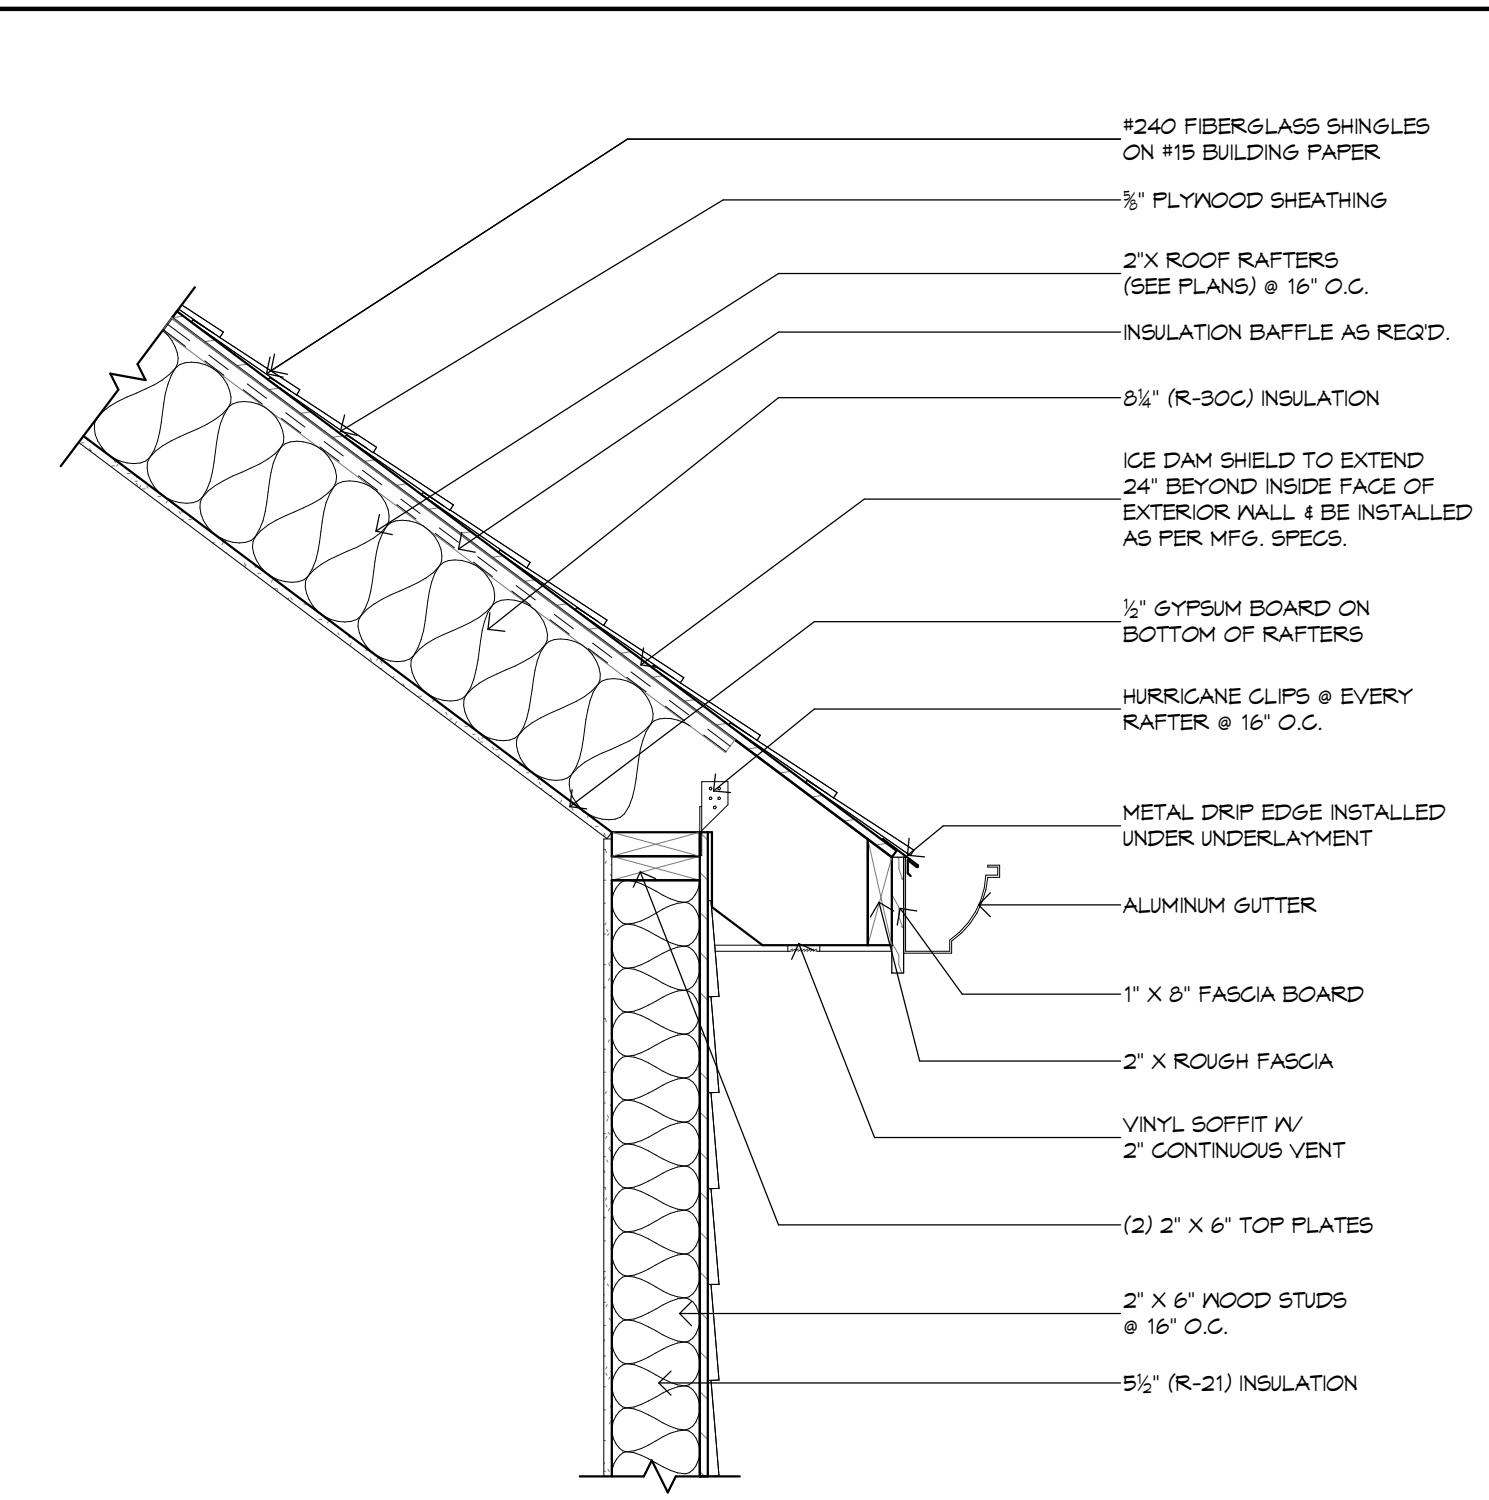
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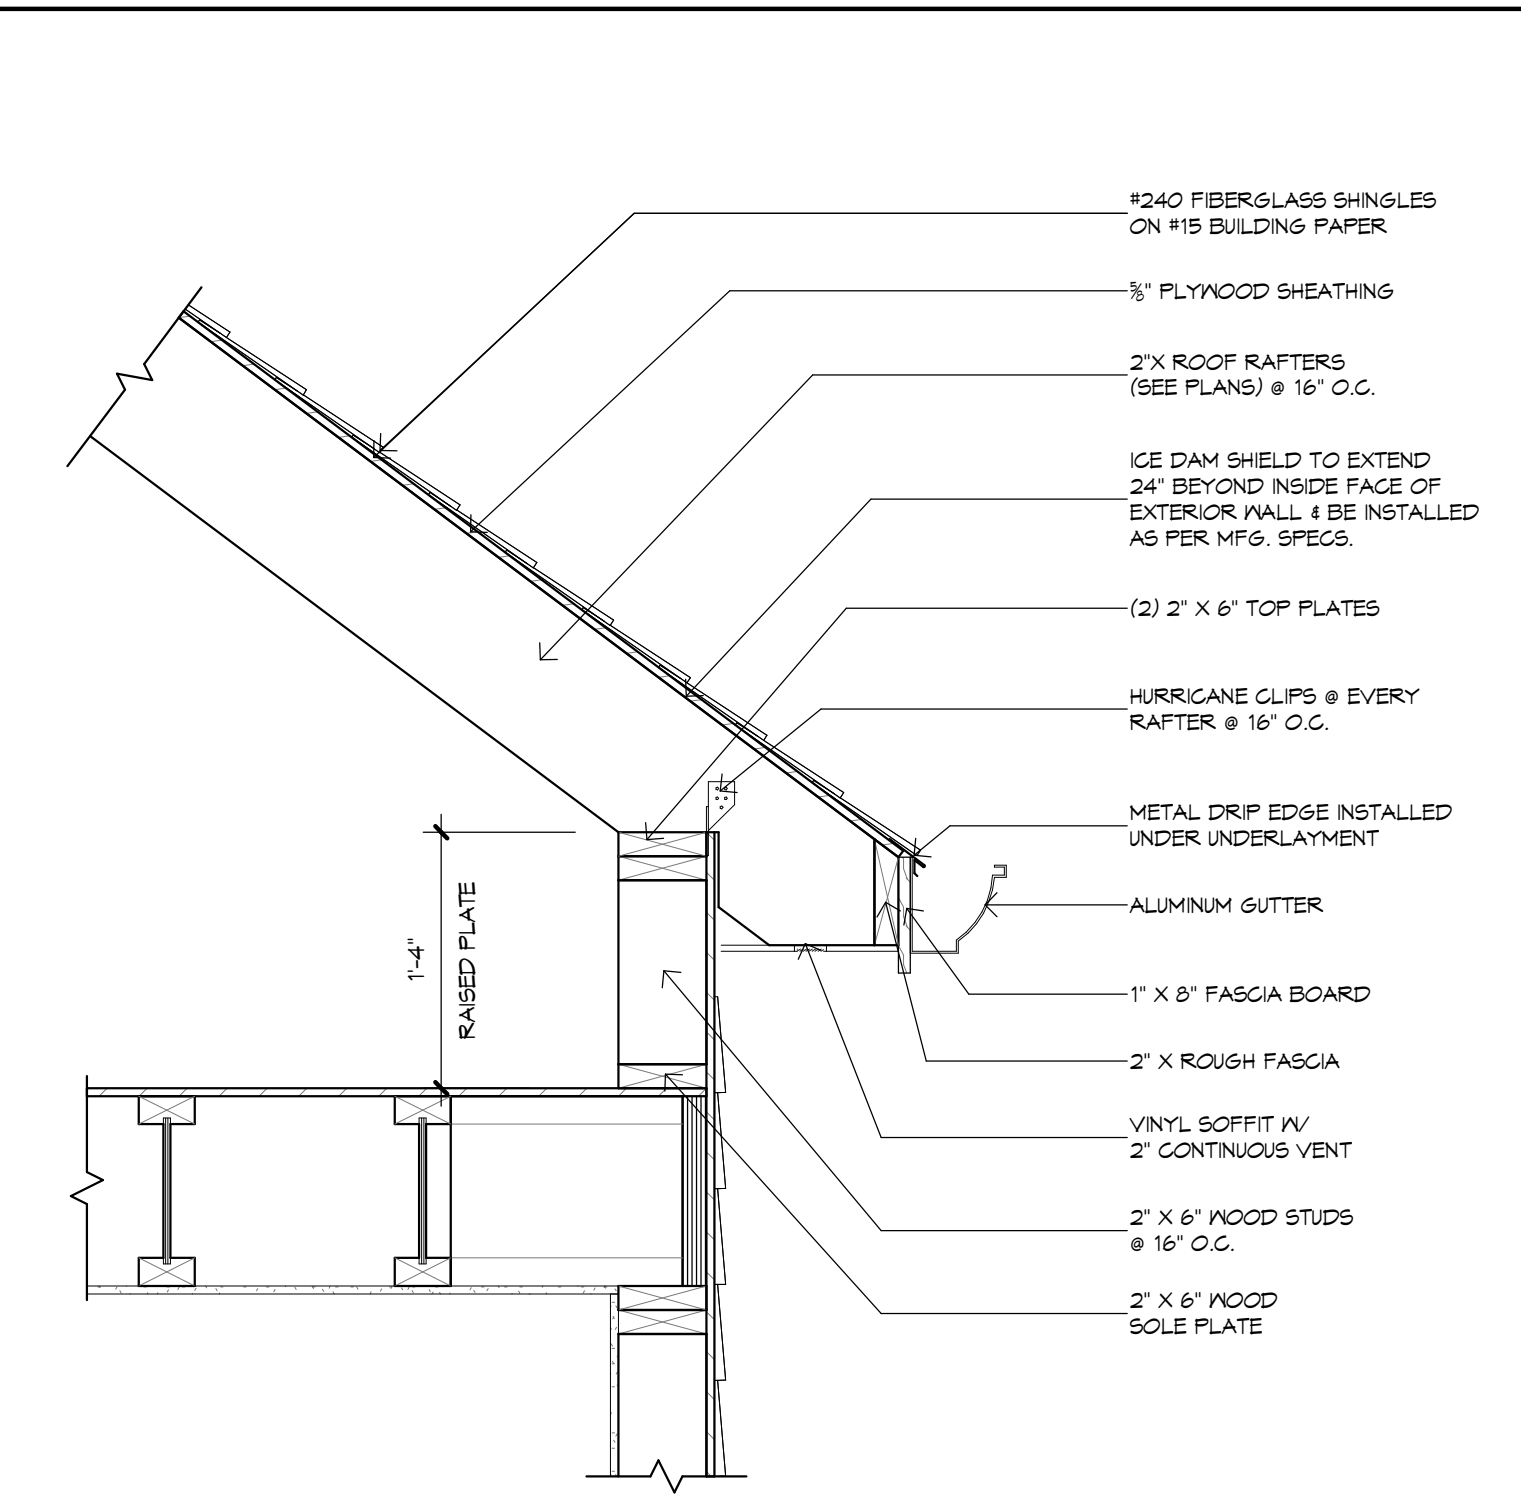
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 Date: 5-15-24
 Sheet No: 6 of 12
 Sheet: **A2.2**

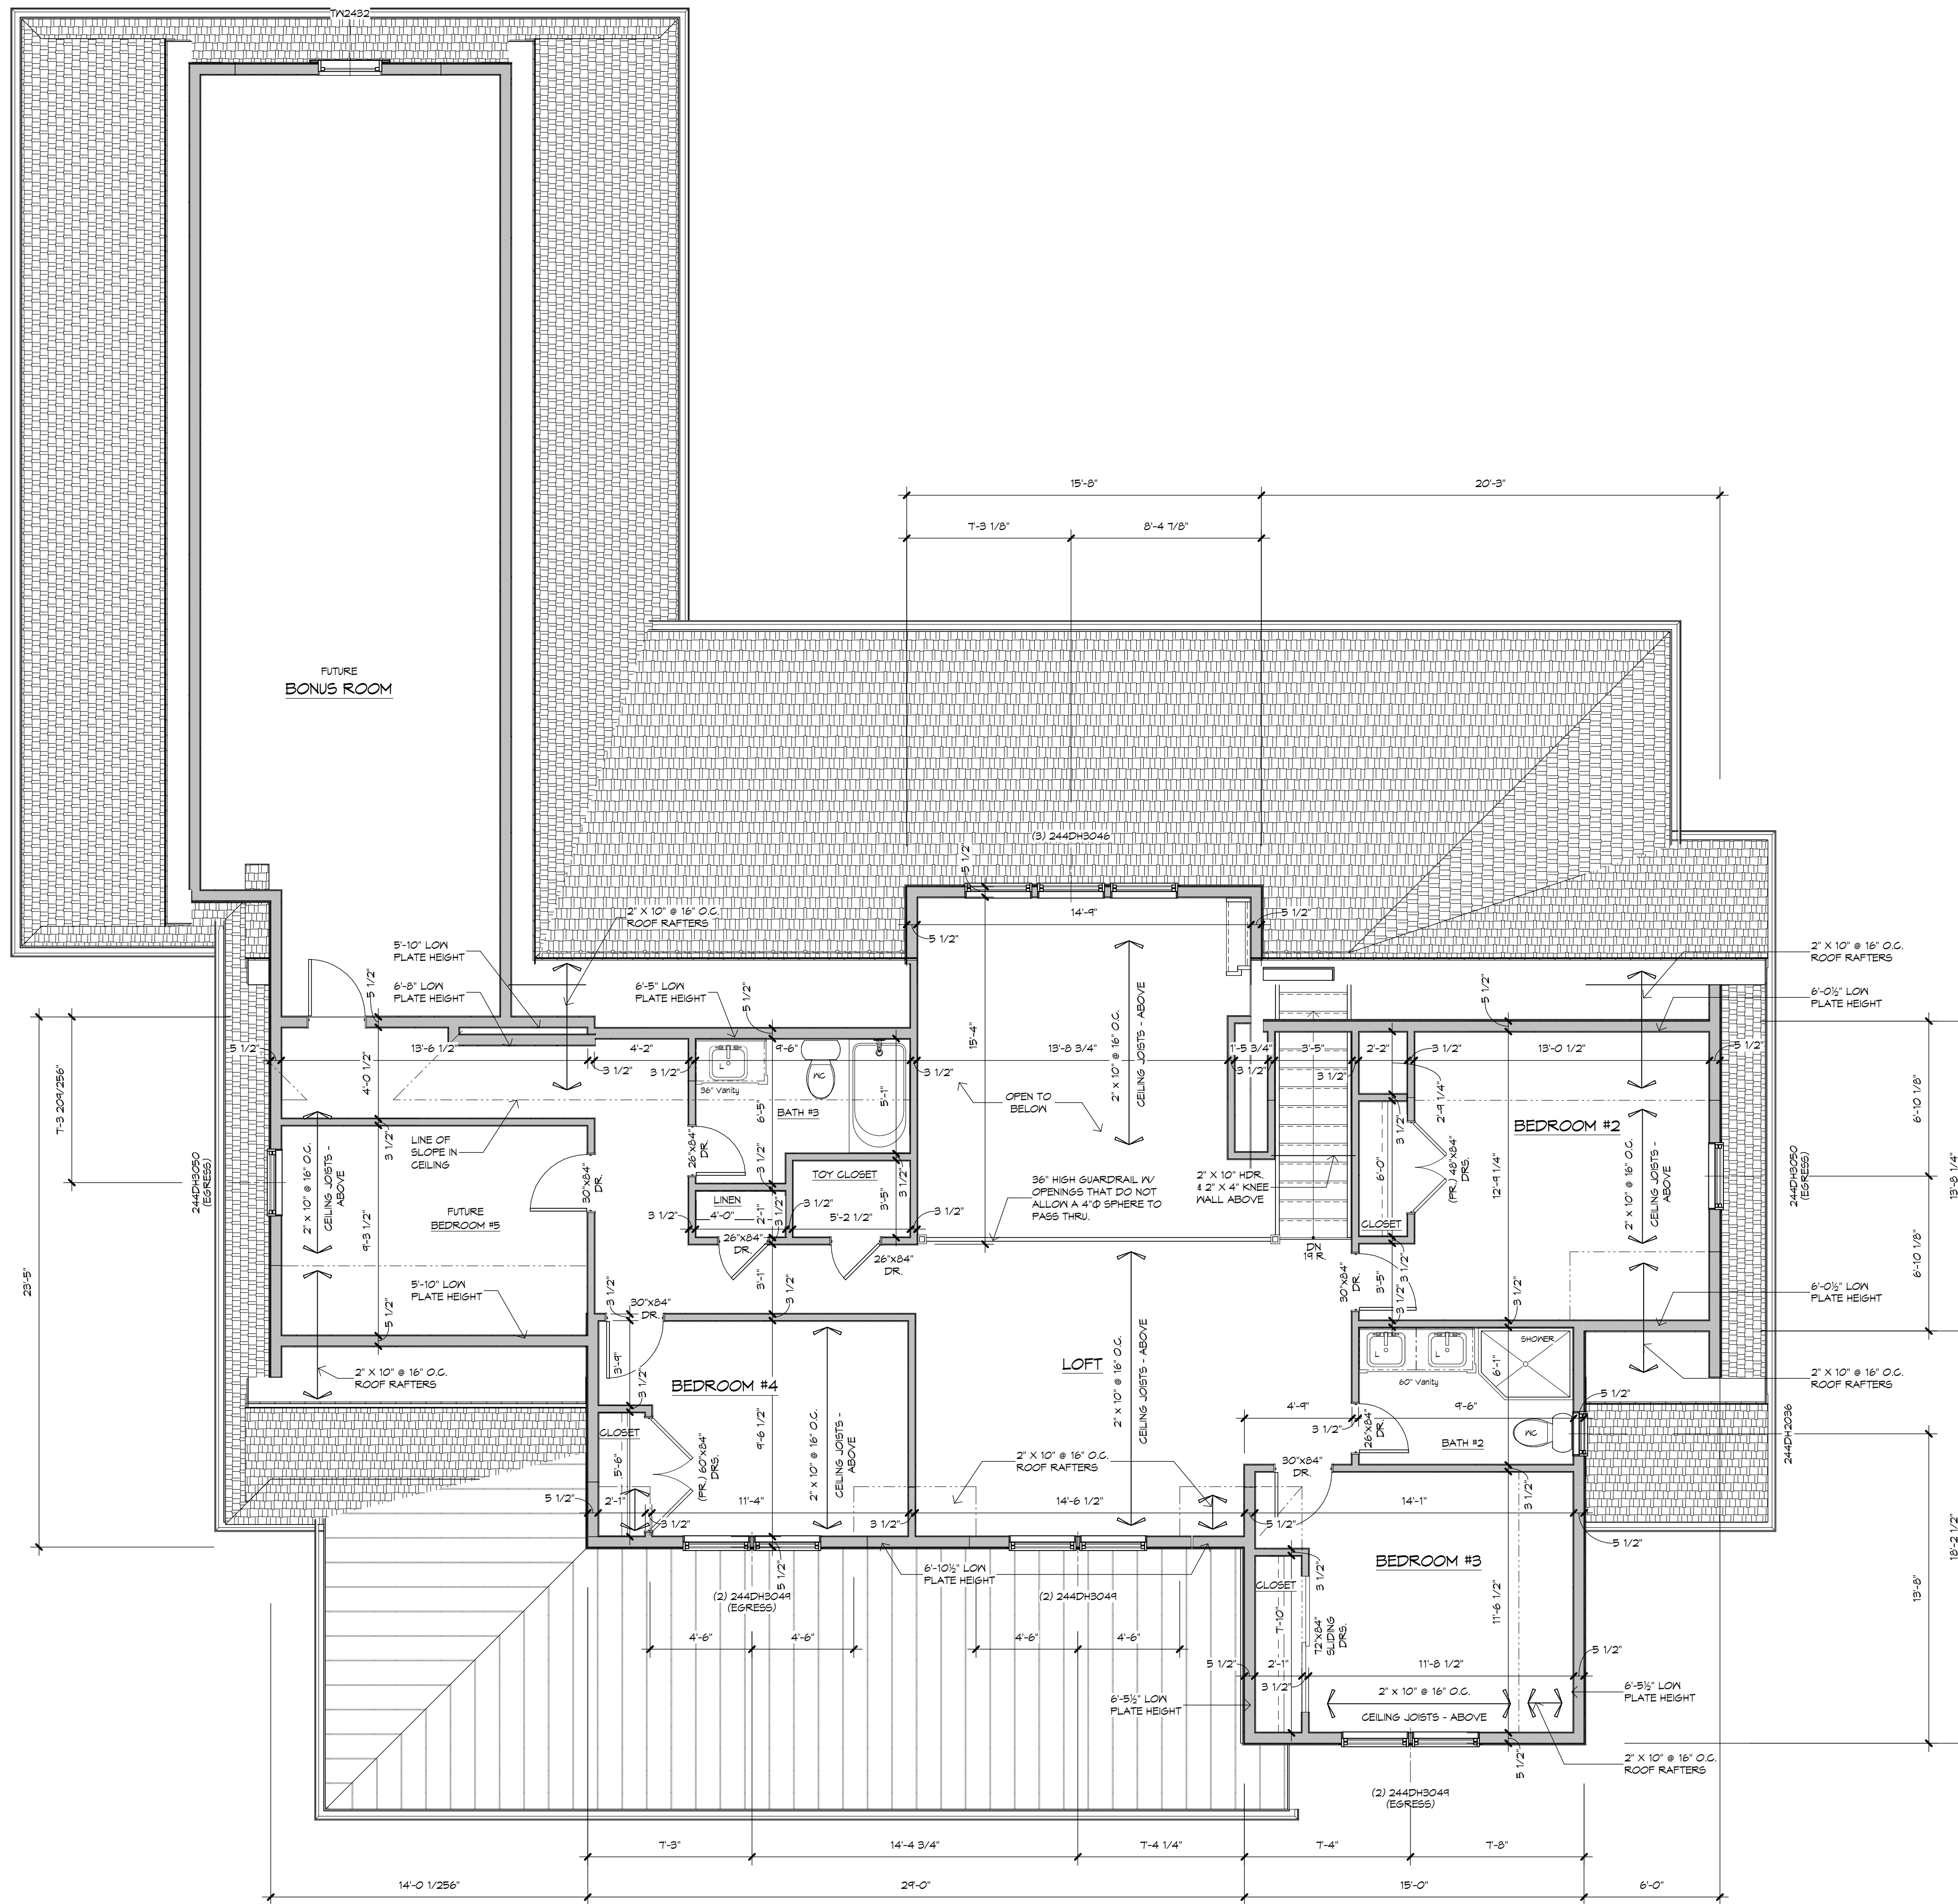

PROPOSED ROOF PLAN
SCALE: 1/4" = 1'-0"



RAISED PLATE DETAIL
SCALE: 1" = 1'-0"



RAKE & EAVE DETAIL
SCALE: 1" = 1'-0"

ROOF CONSTRUCTION

1. ALL HIPS, VALLEYS & RIDGES TO BE 2" X 12'S UNLESS OTHERWISE NOTED.
 2. DOUBLE MEMBERS BELOW DOWN LOAD POSTS.
 3. #240 FIBERGLASS SHINGLES ON #15 BUILDING PAPER ON 3/8" PLYWOOD SHEATHING ON RAFTERS AS SHOWN.
 4. OVERHANGS & GUTTERS AS PER ELEVATION.
 5. PROVIDE 2" X 6" @ 32" O.C. COLLARS & 2" X 4" STRONGBACKS AS REQ'D.
- CONTRACTOR NOTE: IF FIBERGLASS BATT INSULATION IS SELECTED BY OWNER, CONTRACTOR TO PROVIDE CONTINUOUS RIDGE VENT & CONTINUOUS 2" SOFFIT VENT AT ALL ROOF AREAS. IF OWNER SELECTS SPYNE SPRAY FOAM INSULATION RIDGE VENT & SOFFIT VENT SHOULD NOT BE INSTALLED.

NOTE: HORIZONTAL RAFTER SPANS BEYOND 16'-0" & CATHEDRAL CEILINGS TO BE 2" X 10" @ 16" O.C. RAFTERS W/ 8 1/2" (R-30C) INSULATION.

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MILFORD, PA 18337

Drawn By: JB
Job No: 22-095
Date: 5-15-24
Sheet No: 7 of 12
Sheet: A2.3

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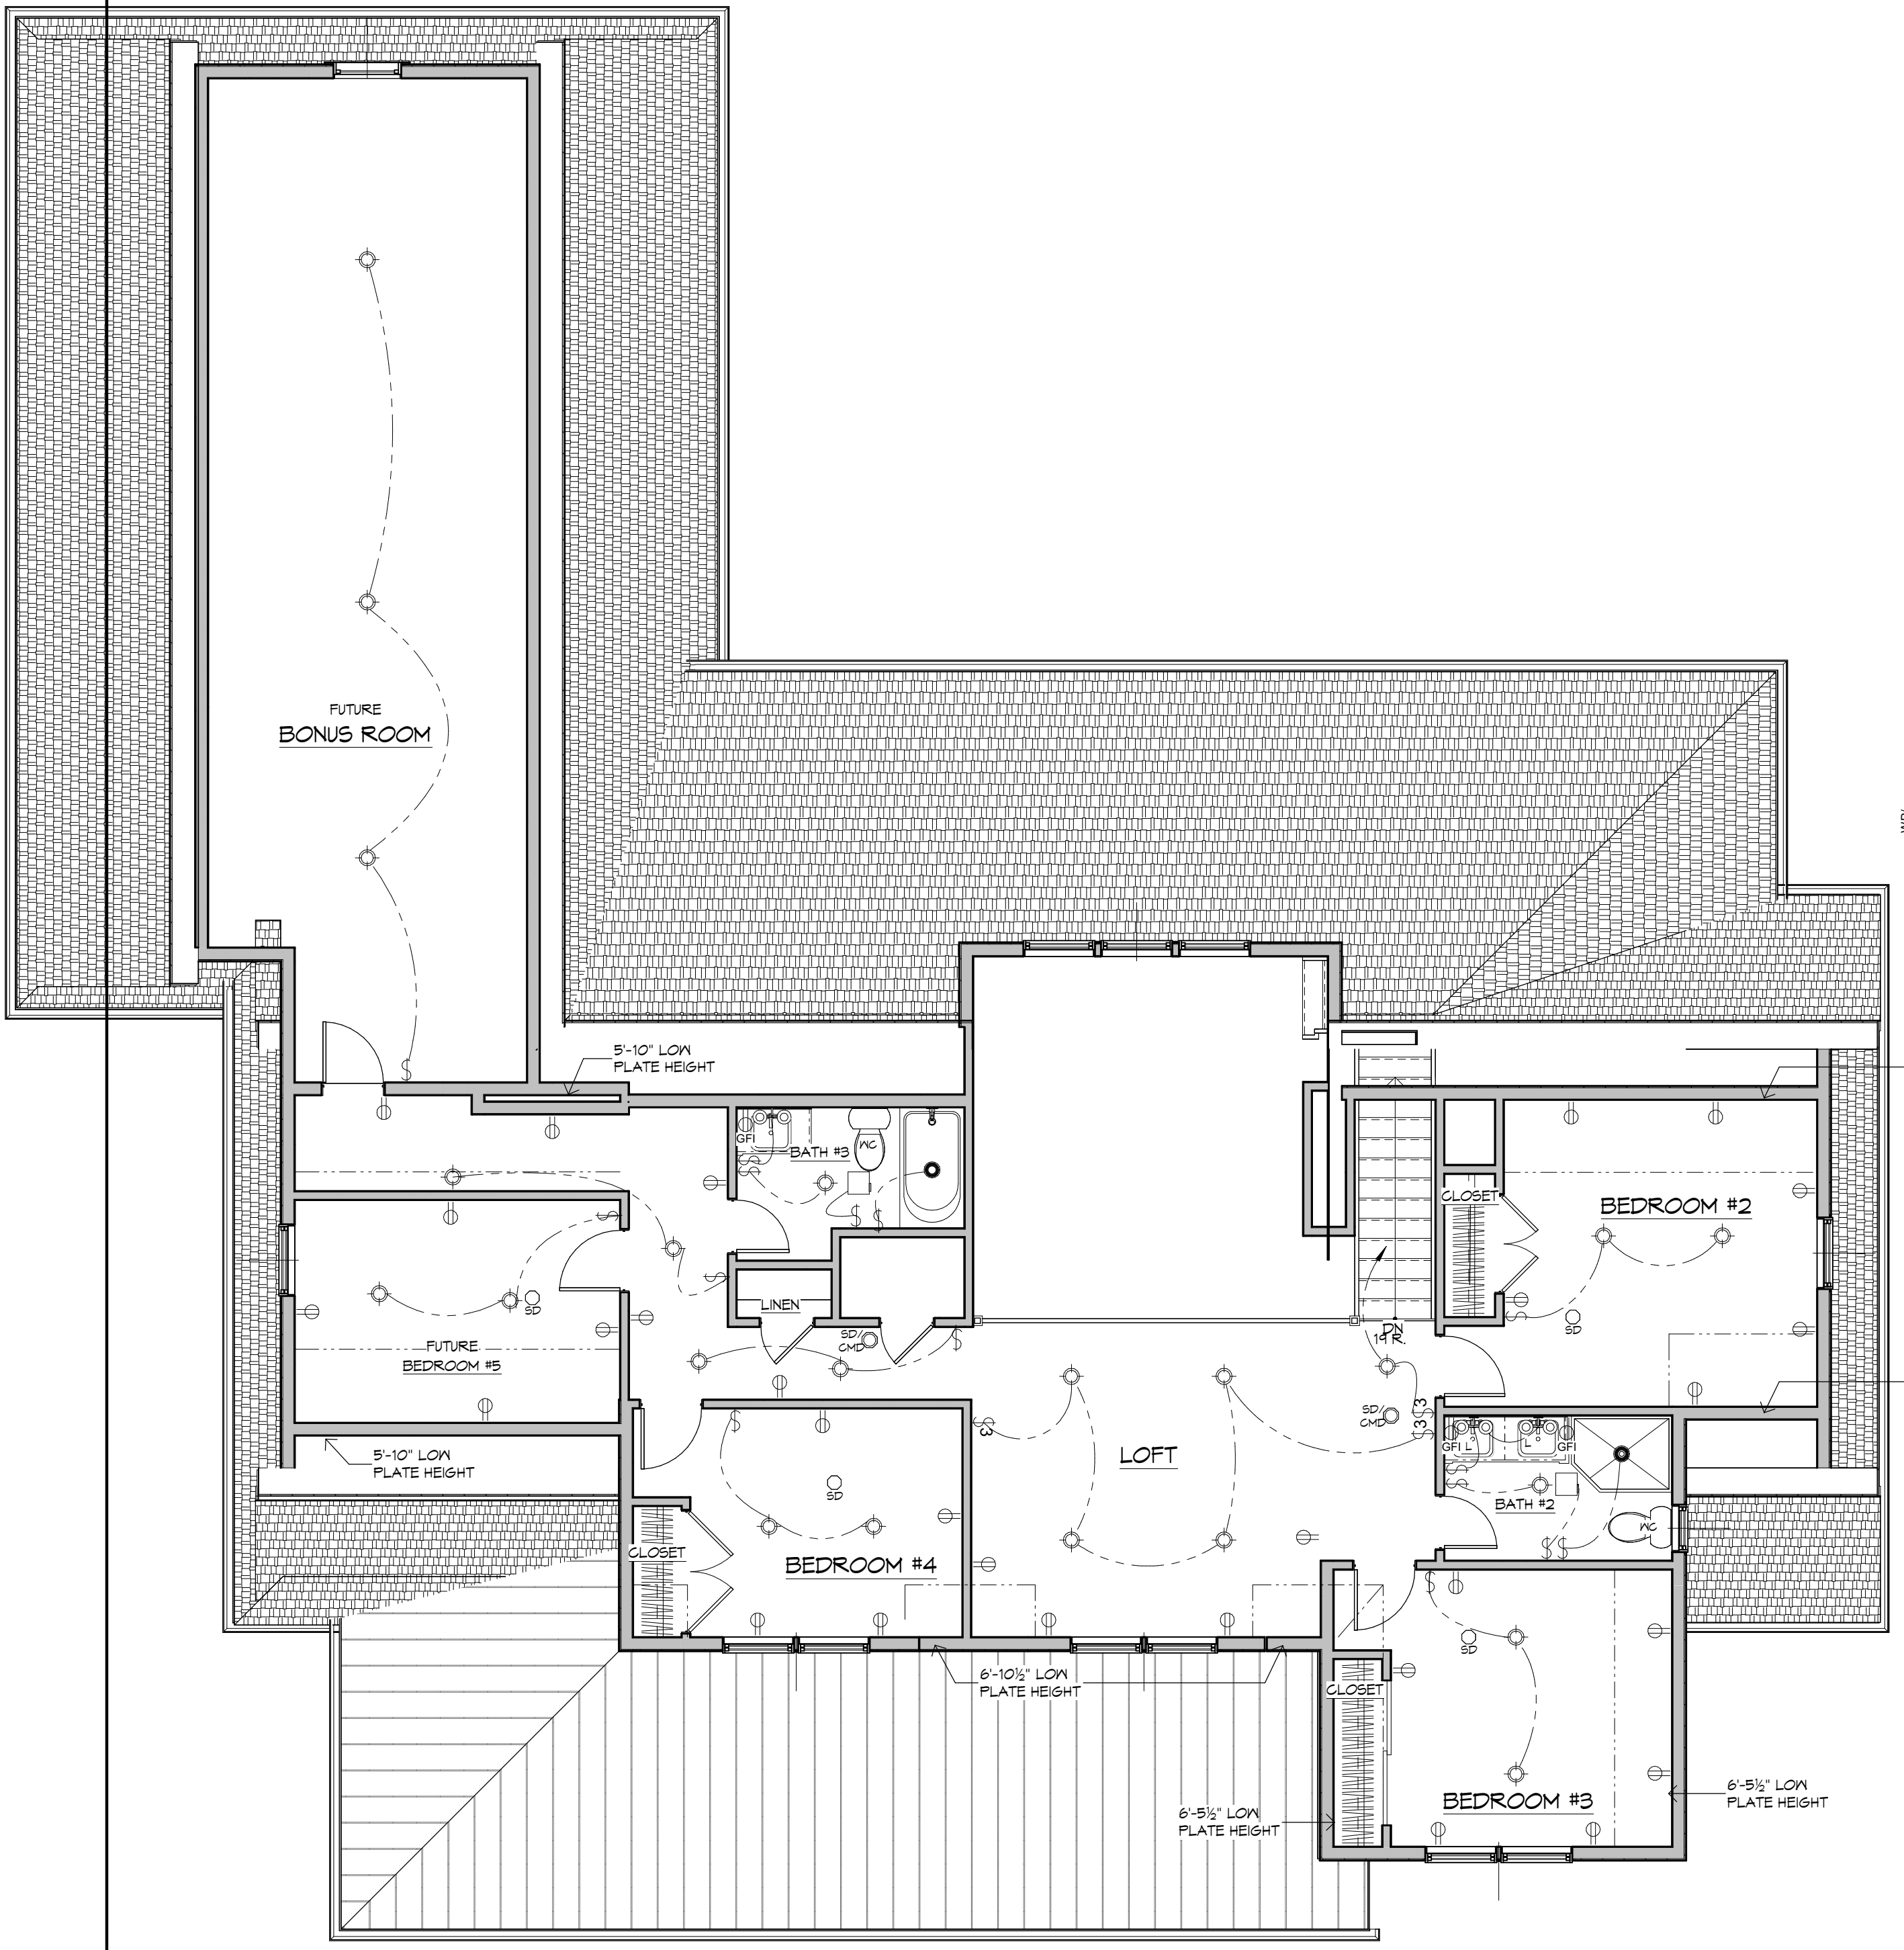
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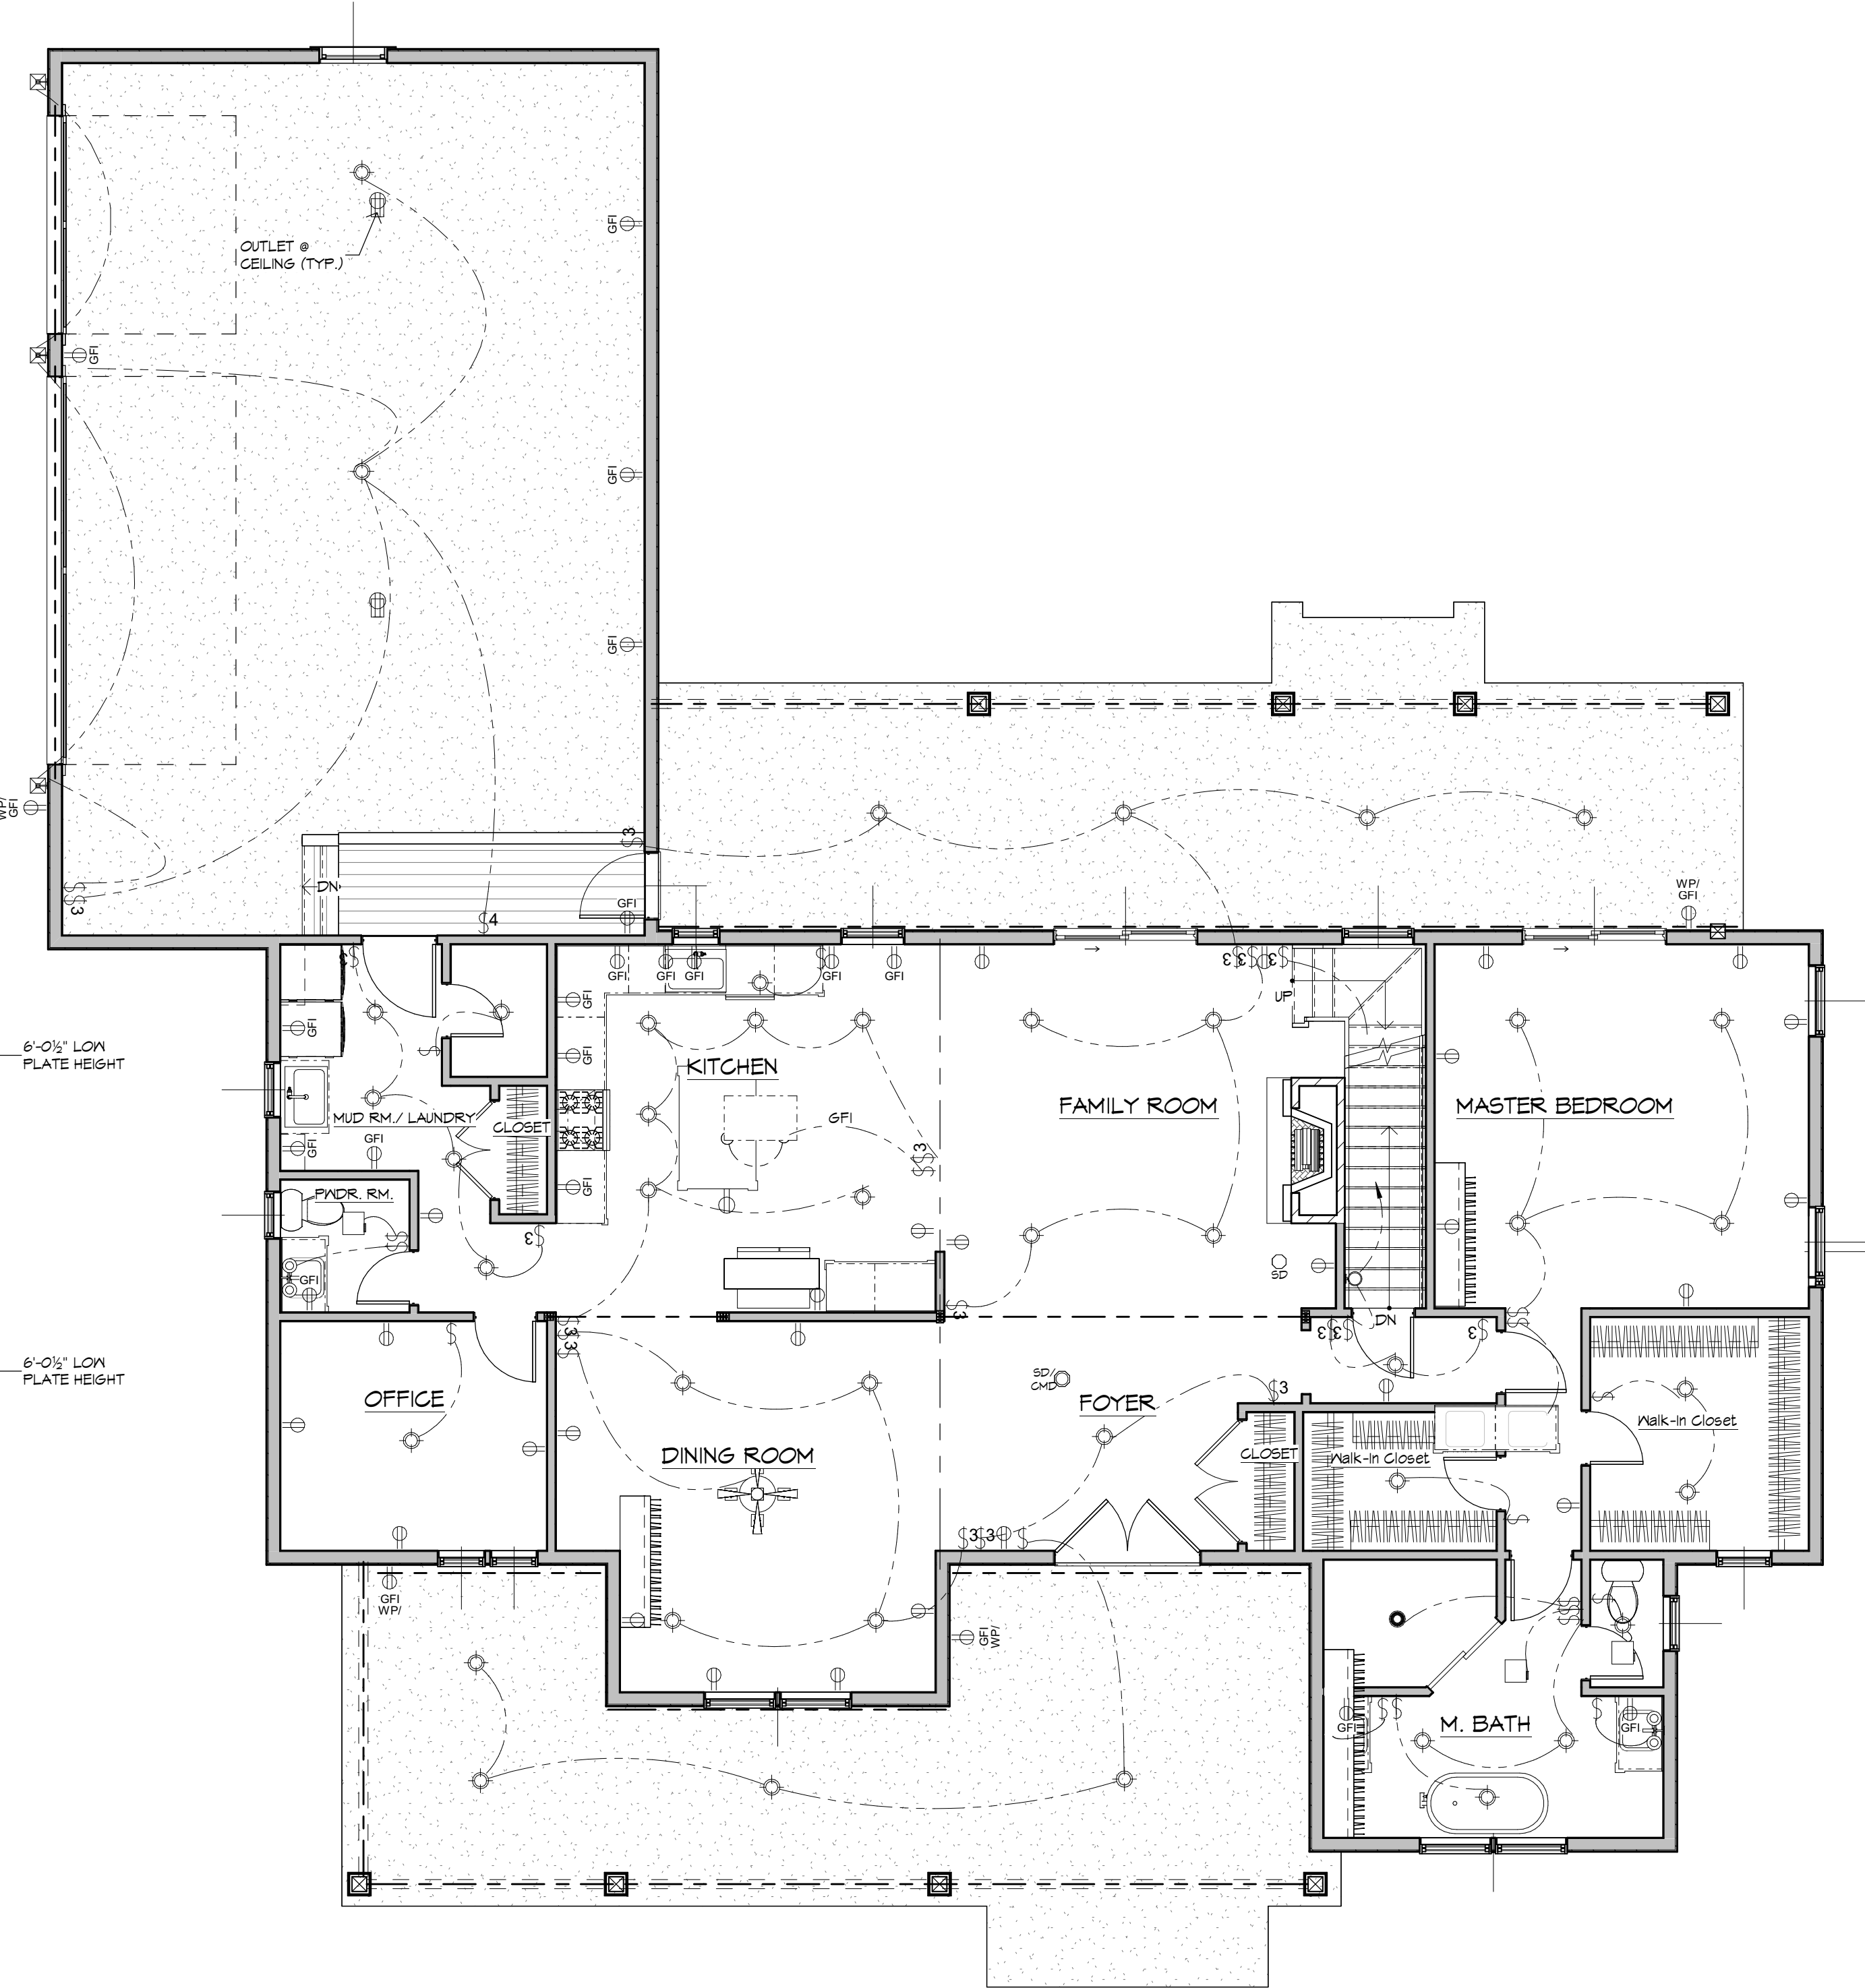
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 Job No: 22-095
 Date: 5-15-24
 Sheet No: 8 of 12
 Sheet: A3.0




SECOND FLOOR ELECTRICAL PLAN
 SCALE: 3/16" = 1'-0"




FIRST FLOOR ELECTRICAL PLAN
 SCALE: 3/16" = 1'-0"

ELECTRICAL LEGEND


- SMOKE DETECTOR: HARDWIRED & INTERCONNECTED
- SMOKE DETECTOR & CARBON MONOXIDE DETECTOR, HARDWIRED & INTERCONNECTED
- WALL MOUNTED (2) BULB LIGHT FIXTURE
- CHANDELIER STYLE LIGHT FIXTURE
- LED RECESSED LIGHT FIXTURE
- WALL MOUNTED EXTERIOR LIGHT FIXTURE
- PENDANT STYLE LIGHT FIXTURE
- VAPOR RETARDANT LIGHT FIXTURE
- WALL MOUNTED SINGLE LIGHT FIXTURE
- DUPLEX OUTLET
- GROUND FAULT INTERRUPT DUPLEX OUTLET
- WEATHER PROOF GROUND FAULT INTERRUPT DUPLEX OUTLET
- SINGLE POLE SWITCH
- THREE WAY SWITCH
- FOUR WAY SWITCH
- EXHAUST FAN
- ELECTRICAL PANEL

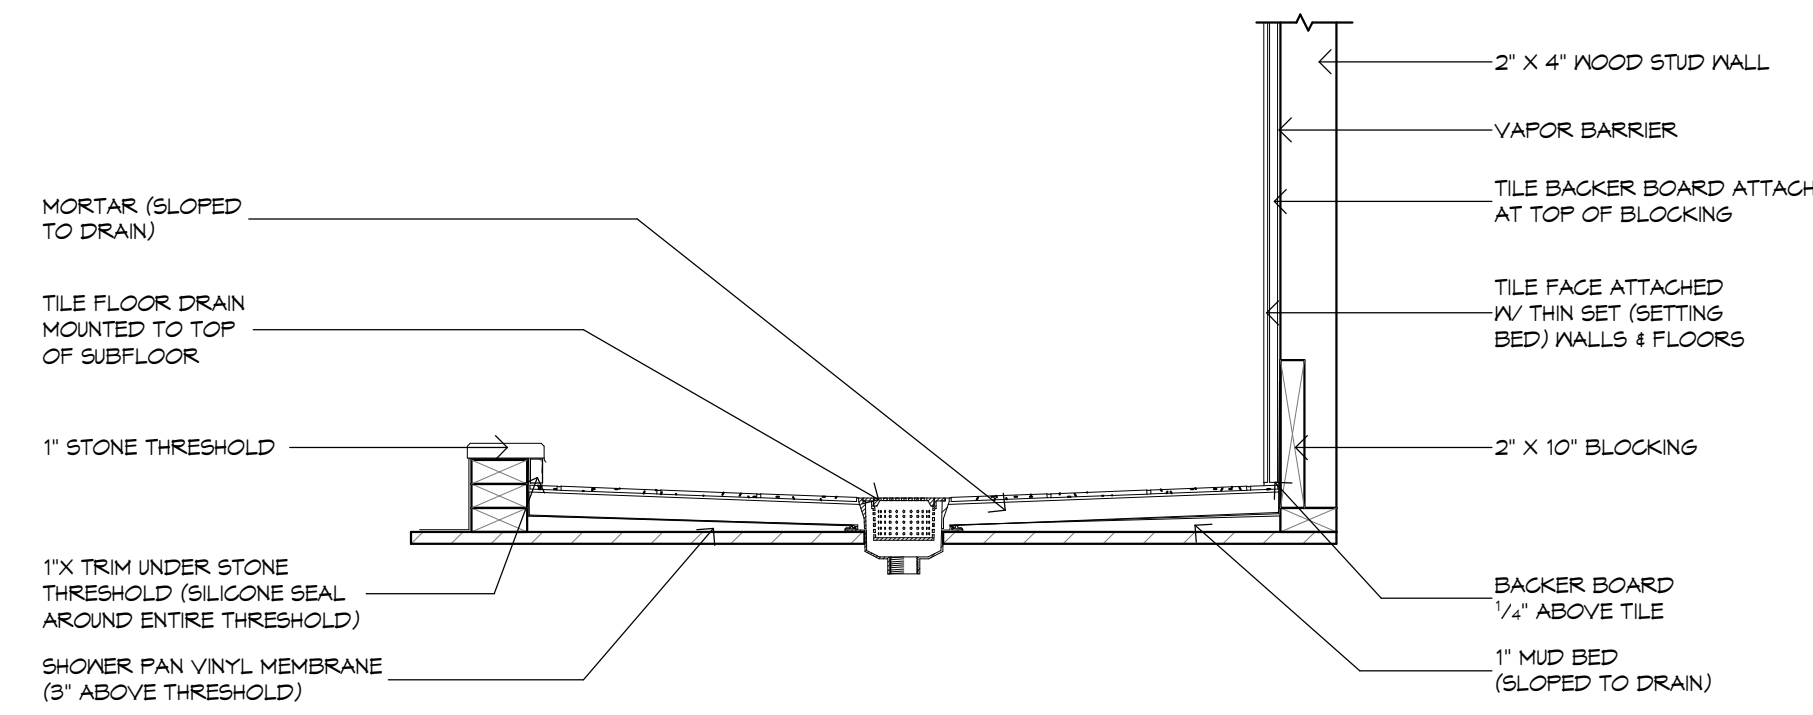


SHOWER PAN DETAIL
SCALE: 1" = 1'-0"

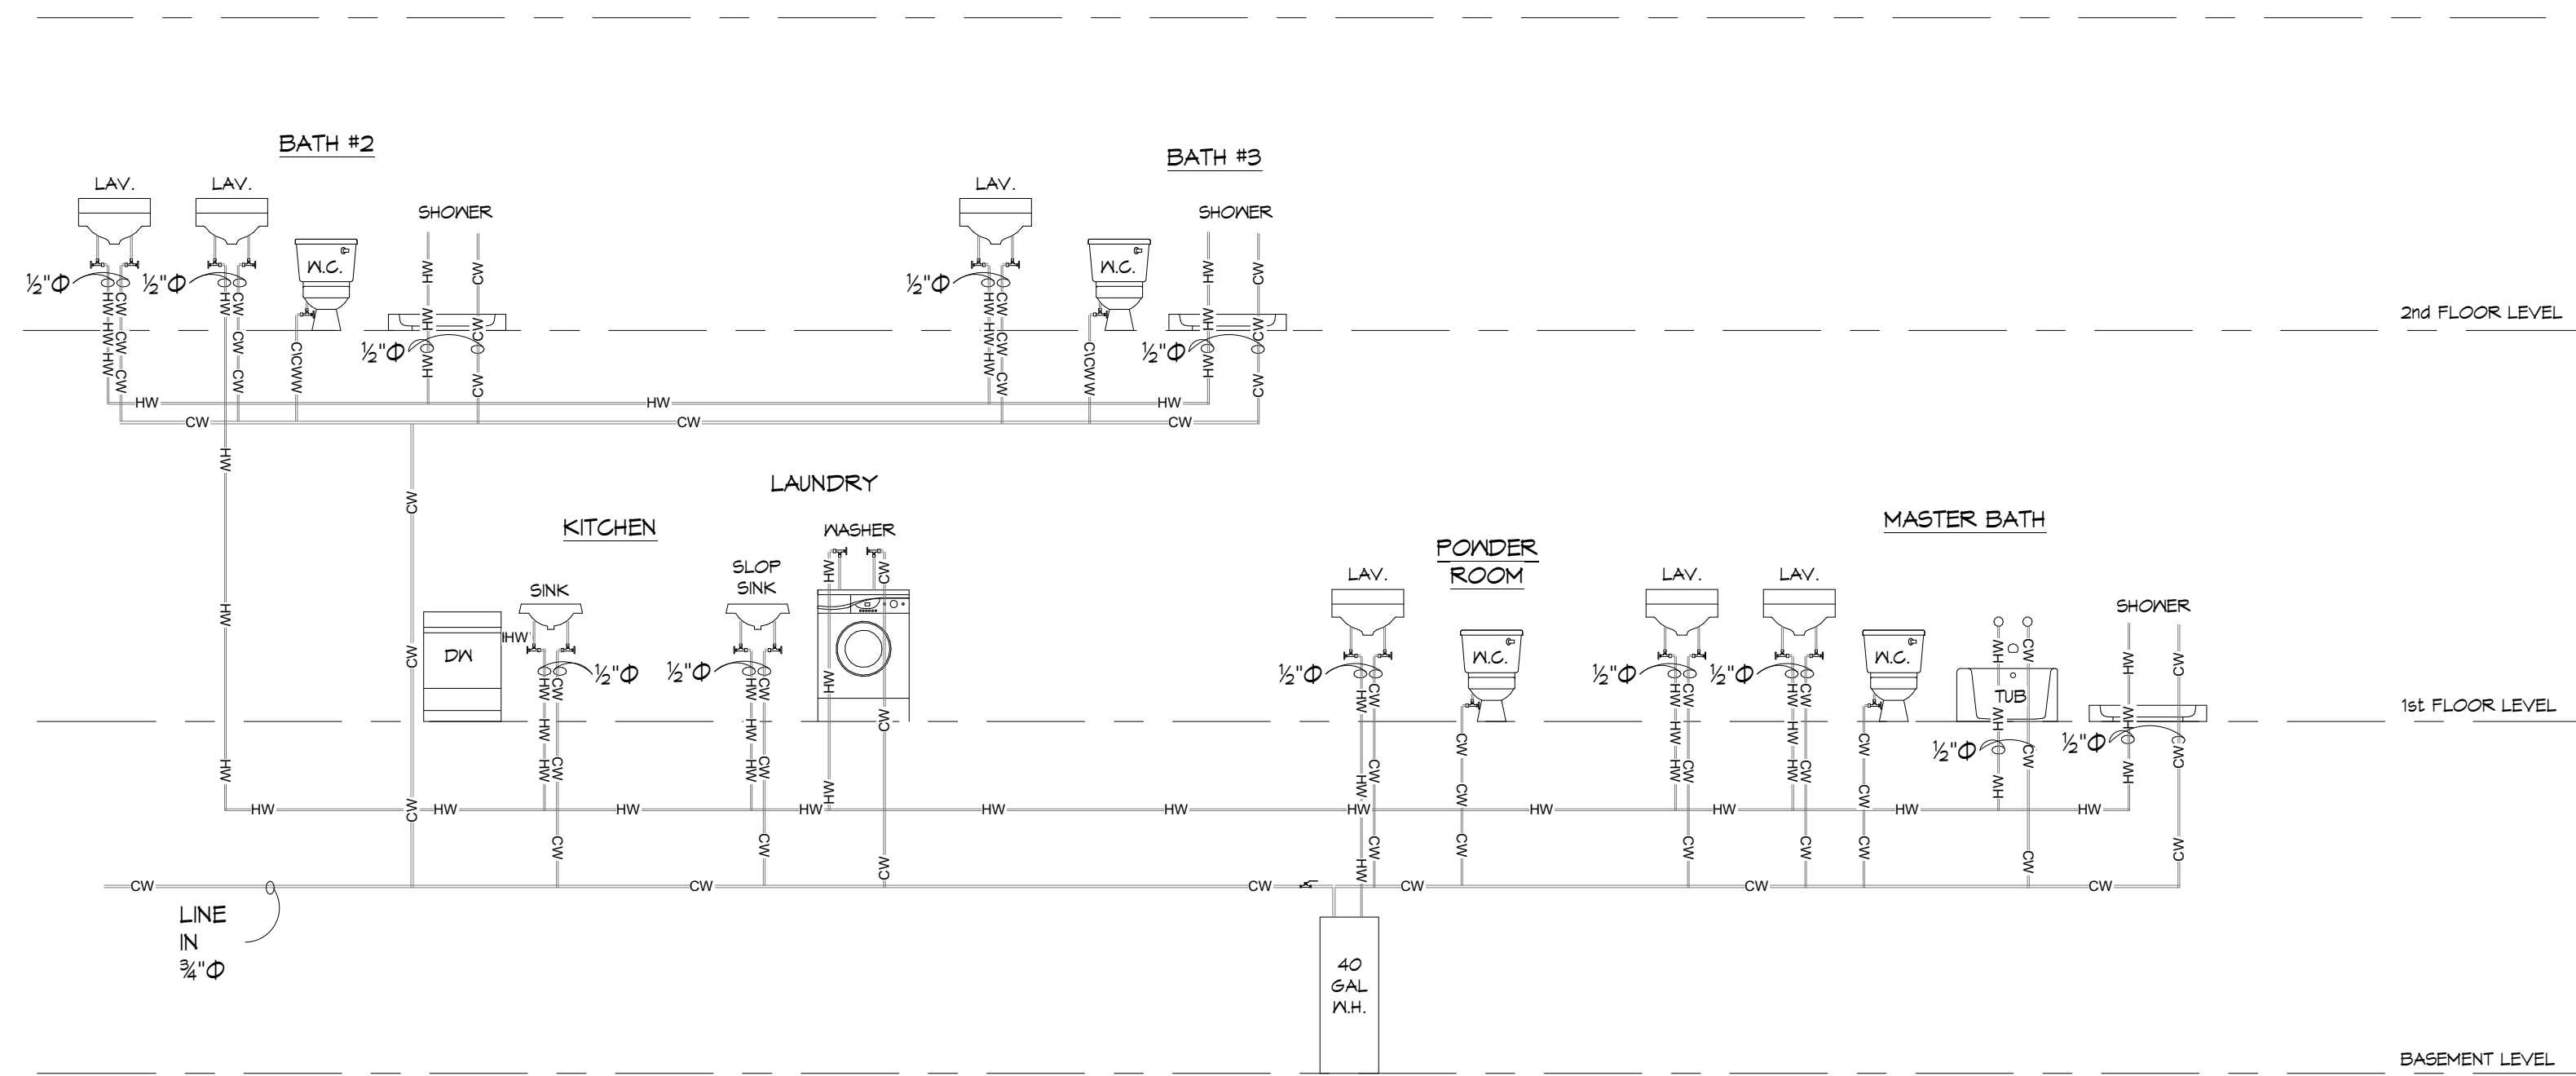

PLUMBING SUPPLY RISER DIAGRAM
SCALE: 1/4" = 1'-0"

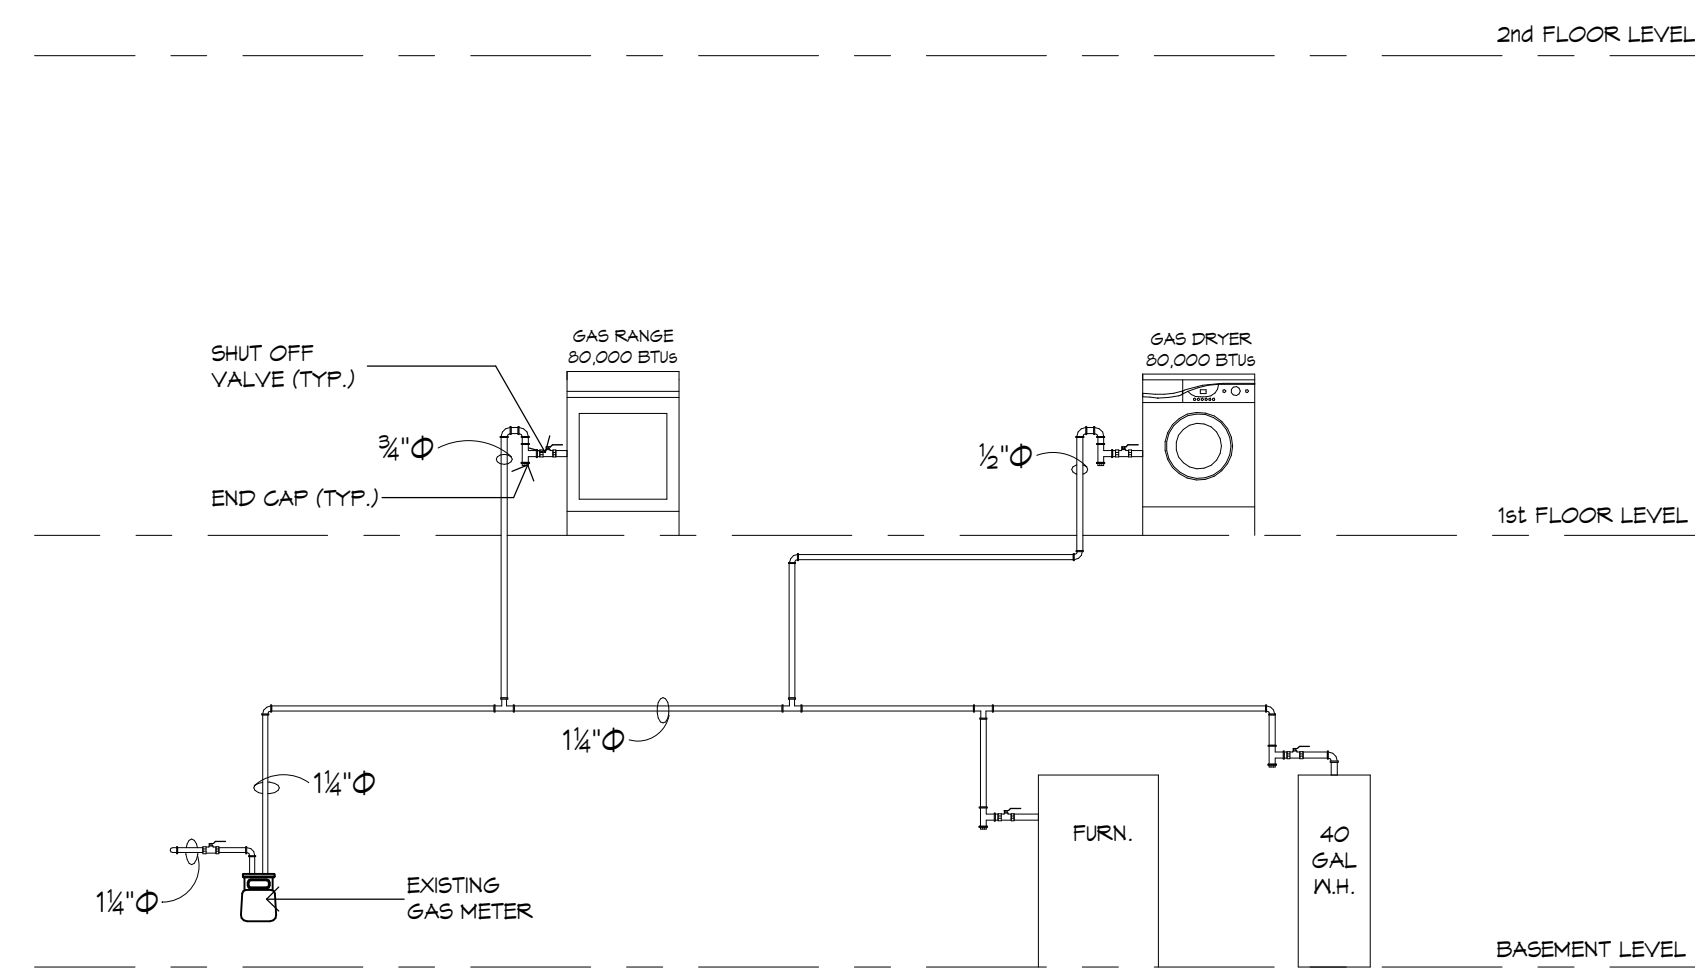

GAS RISER DIAGRAM
SCALE: 1/4" = 1'-0"

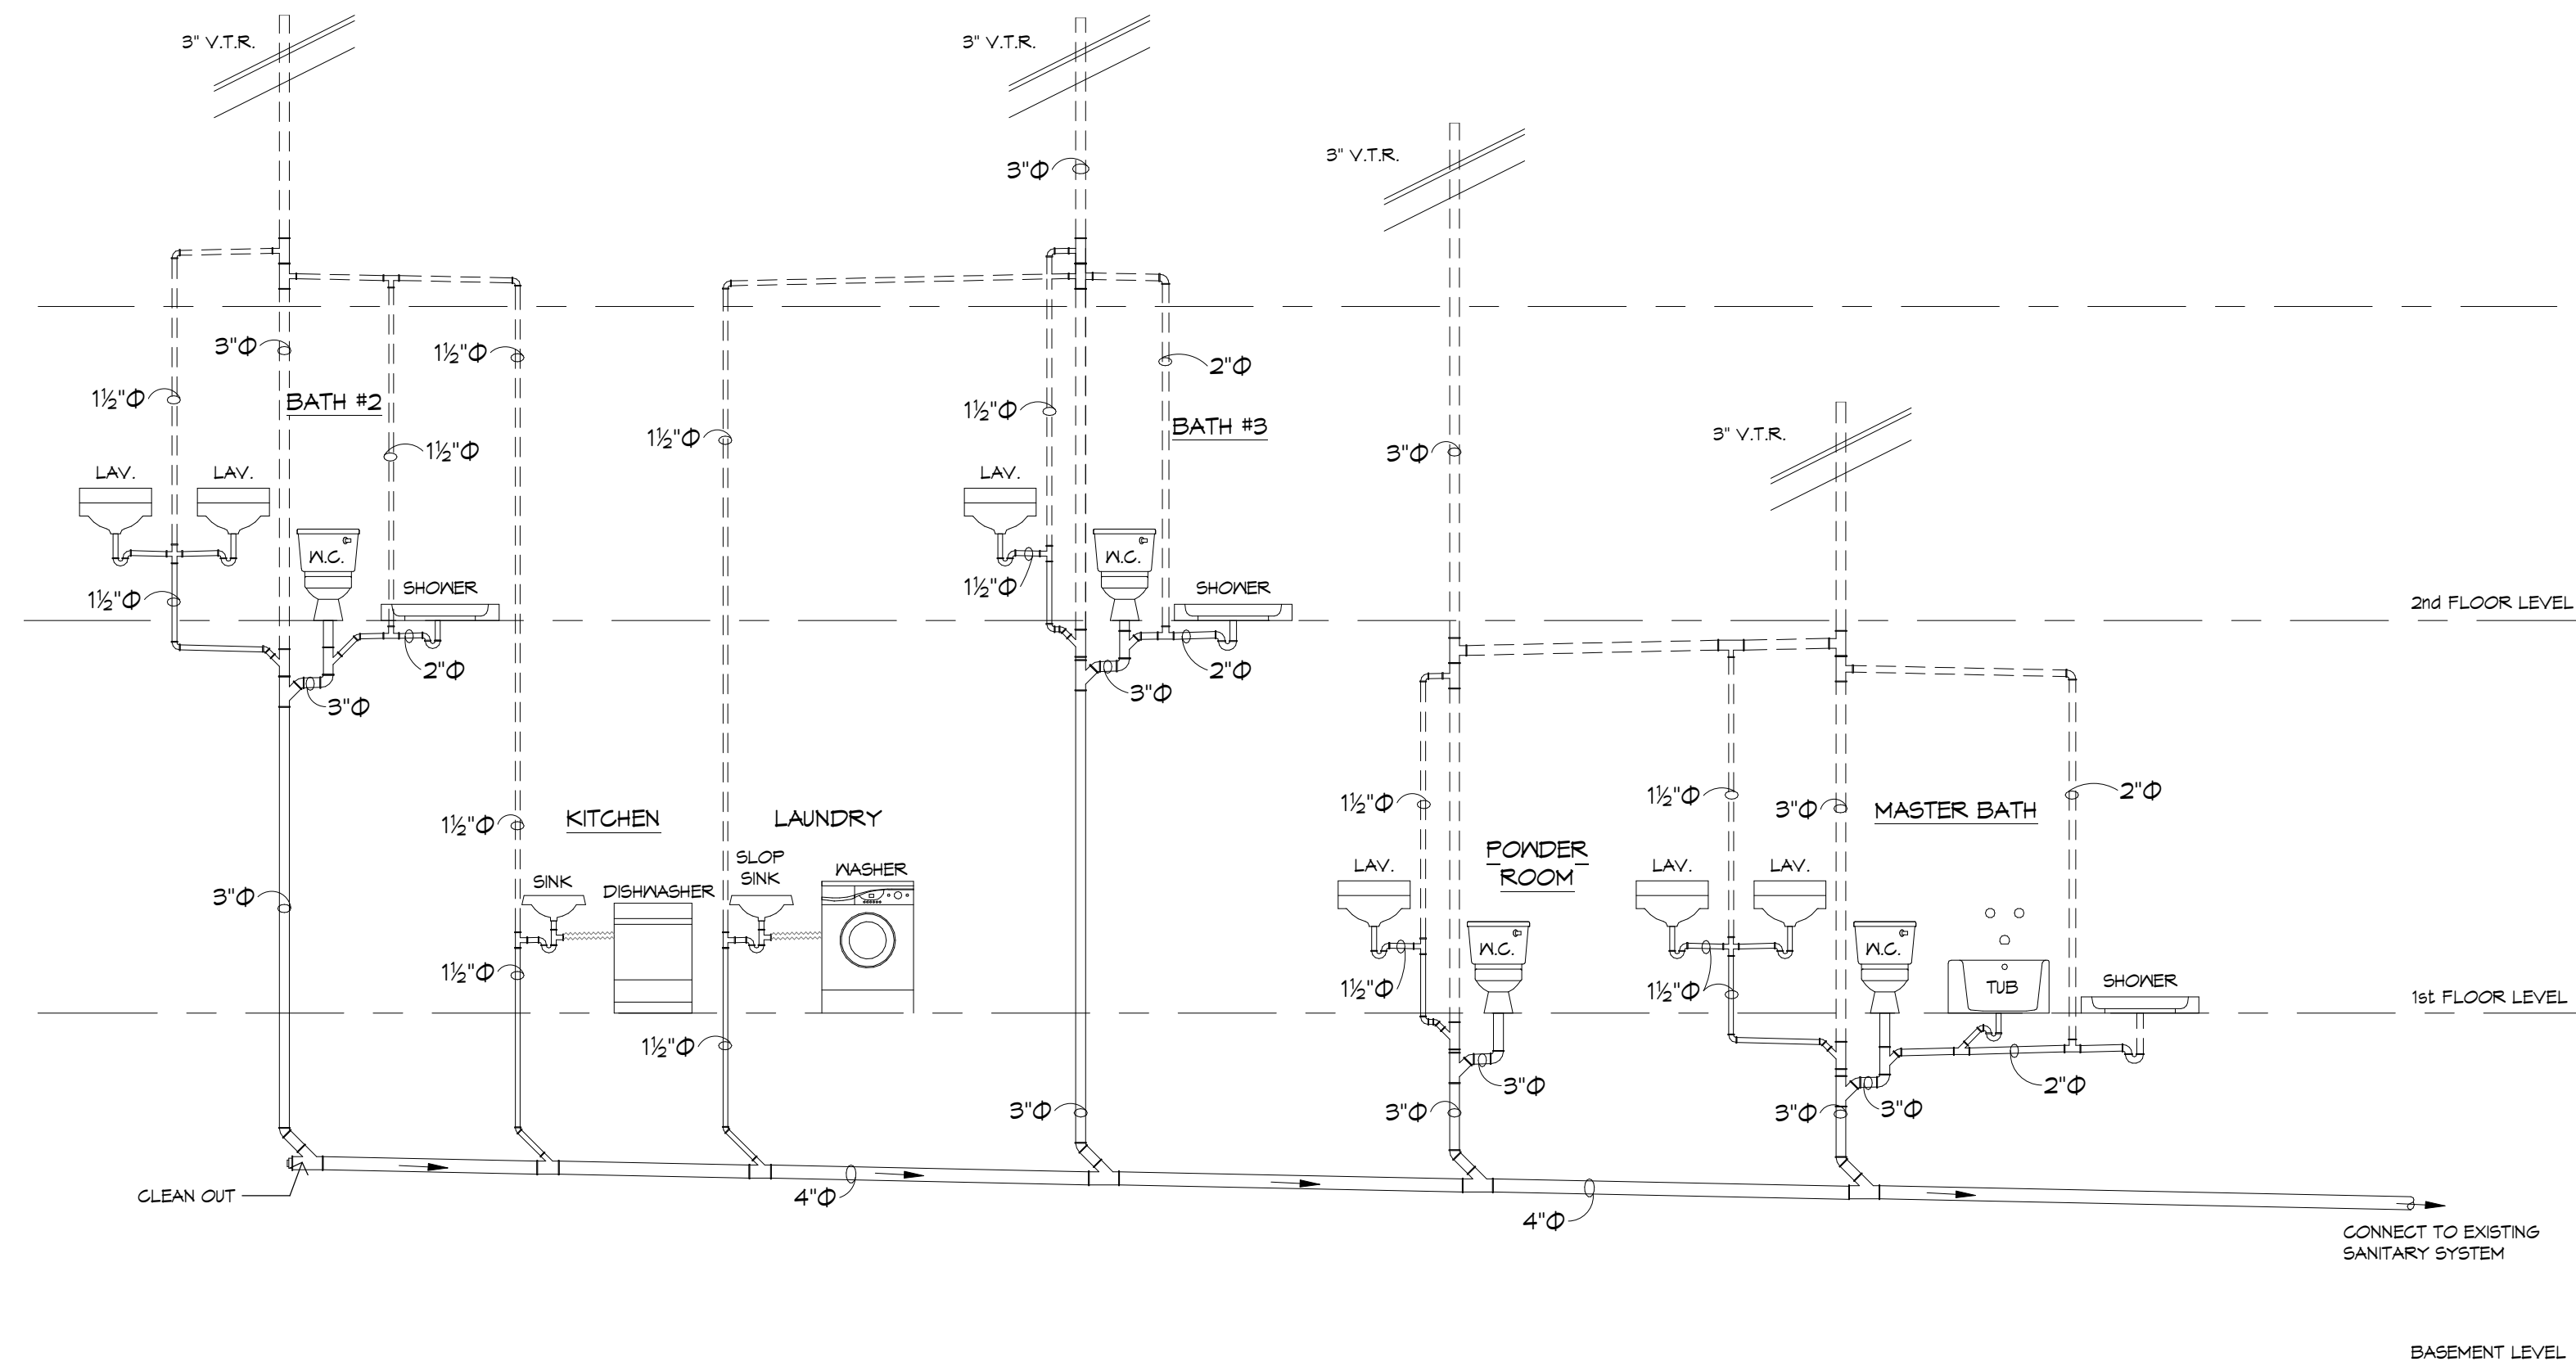

PLUMBING RISER DIAGRAM
SCALE: 1/4" = 1'-0"

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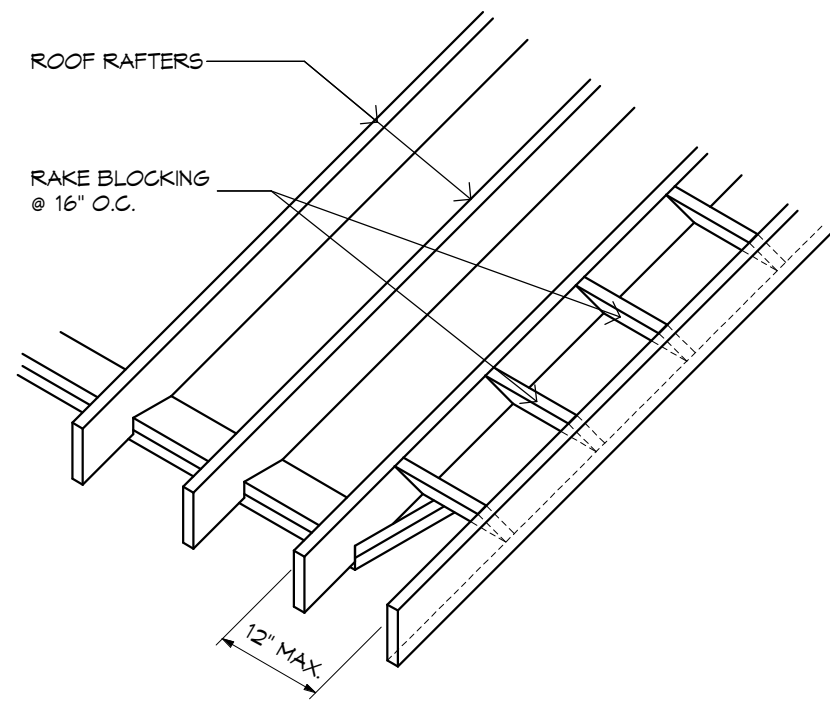
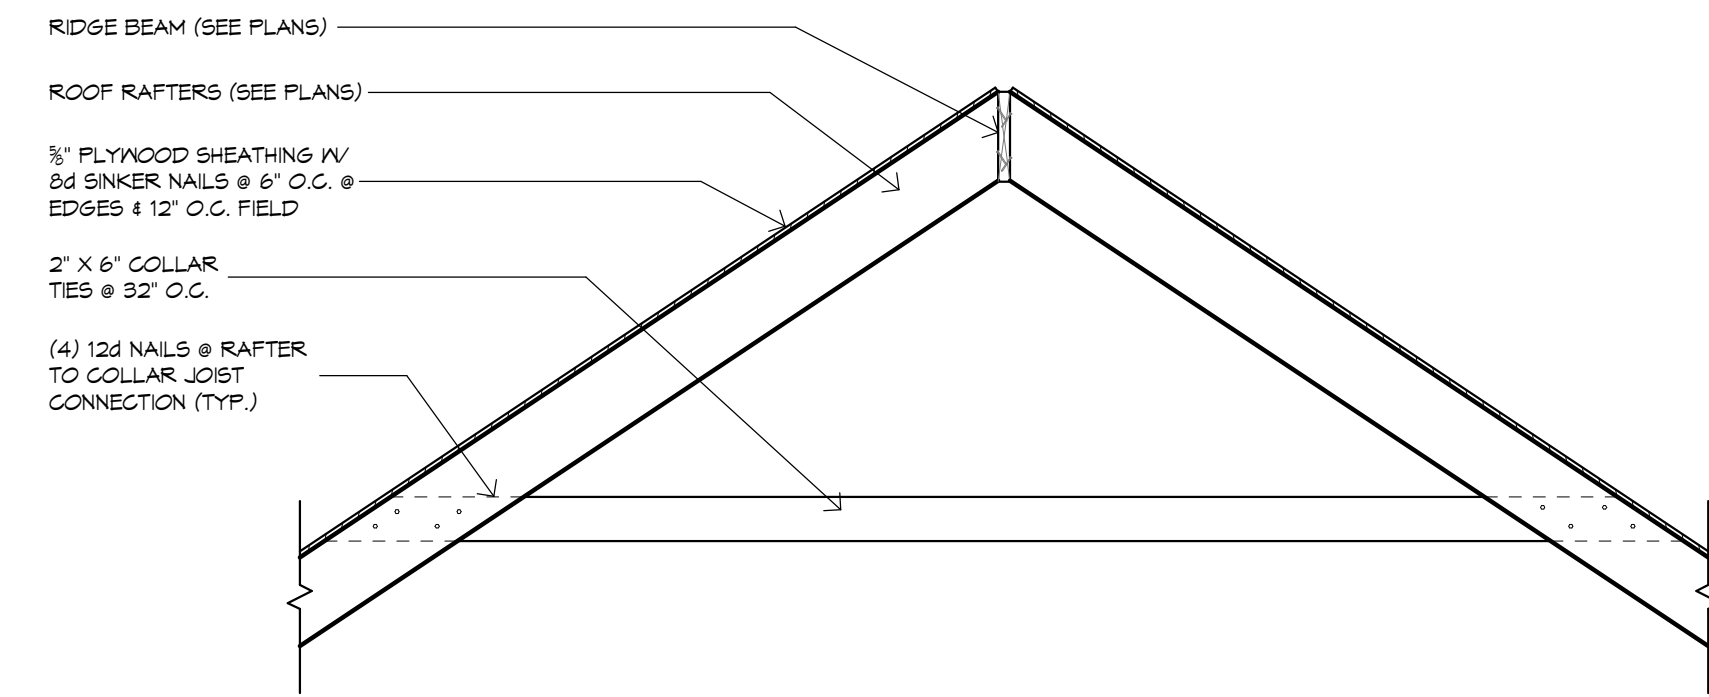
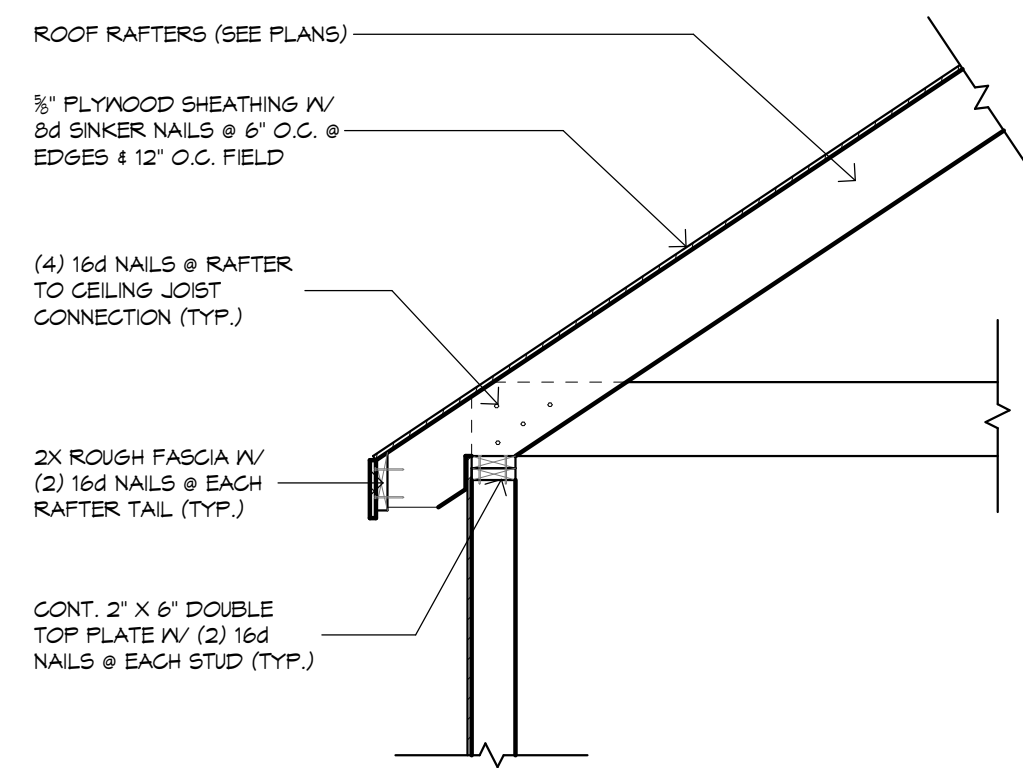
Number	Date	Description

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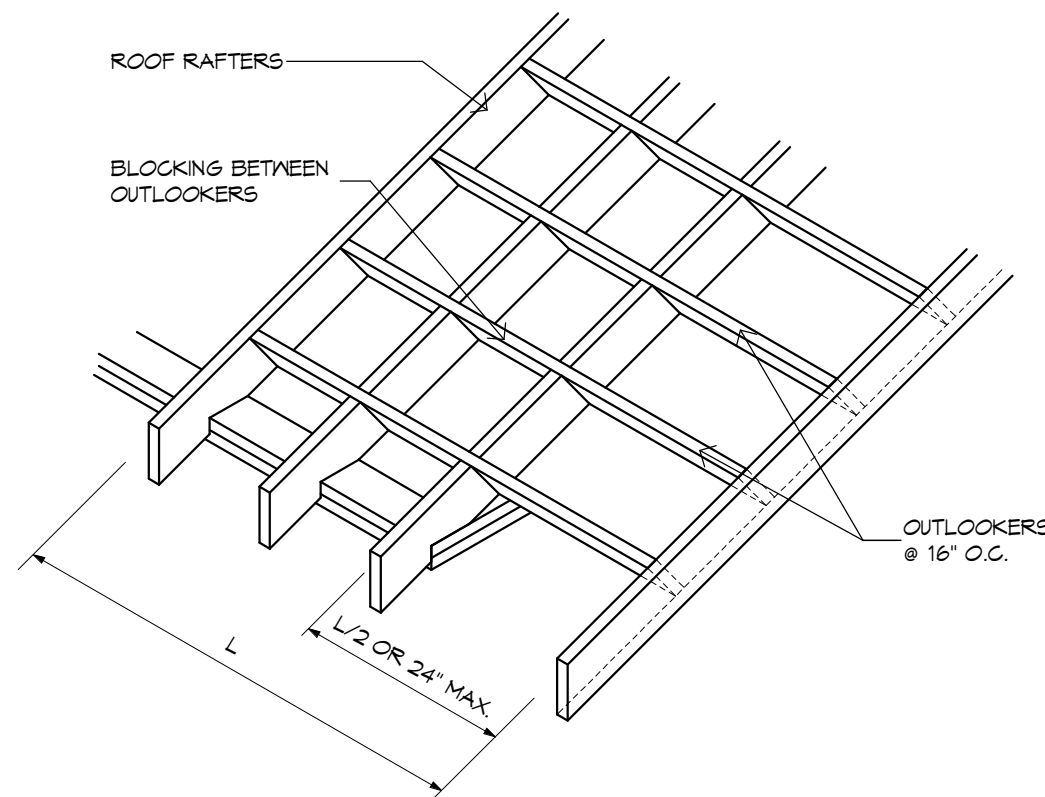
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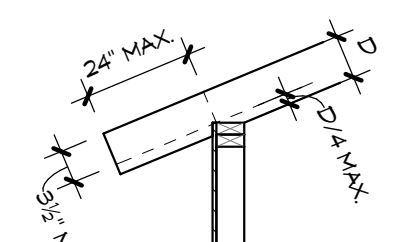
Drawn By: JB
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Sheet No: 9 of 12
Sheet: A3.1




RAKE OVERHANG - BLOCKING




RAKE OVERHANG - OUTLOOKERS



RAFTER NOTCH

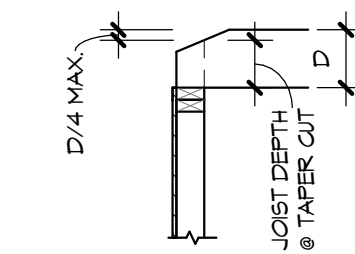


CEILING JOIST TAPER CUT

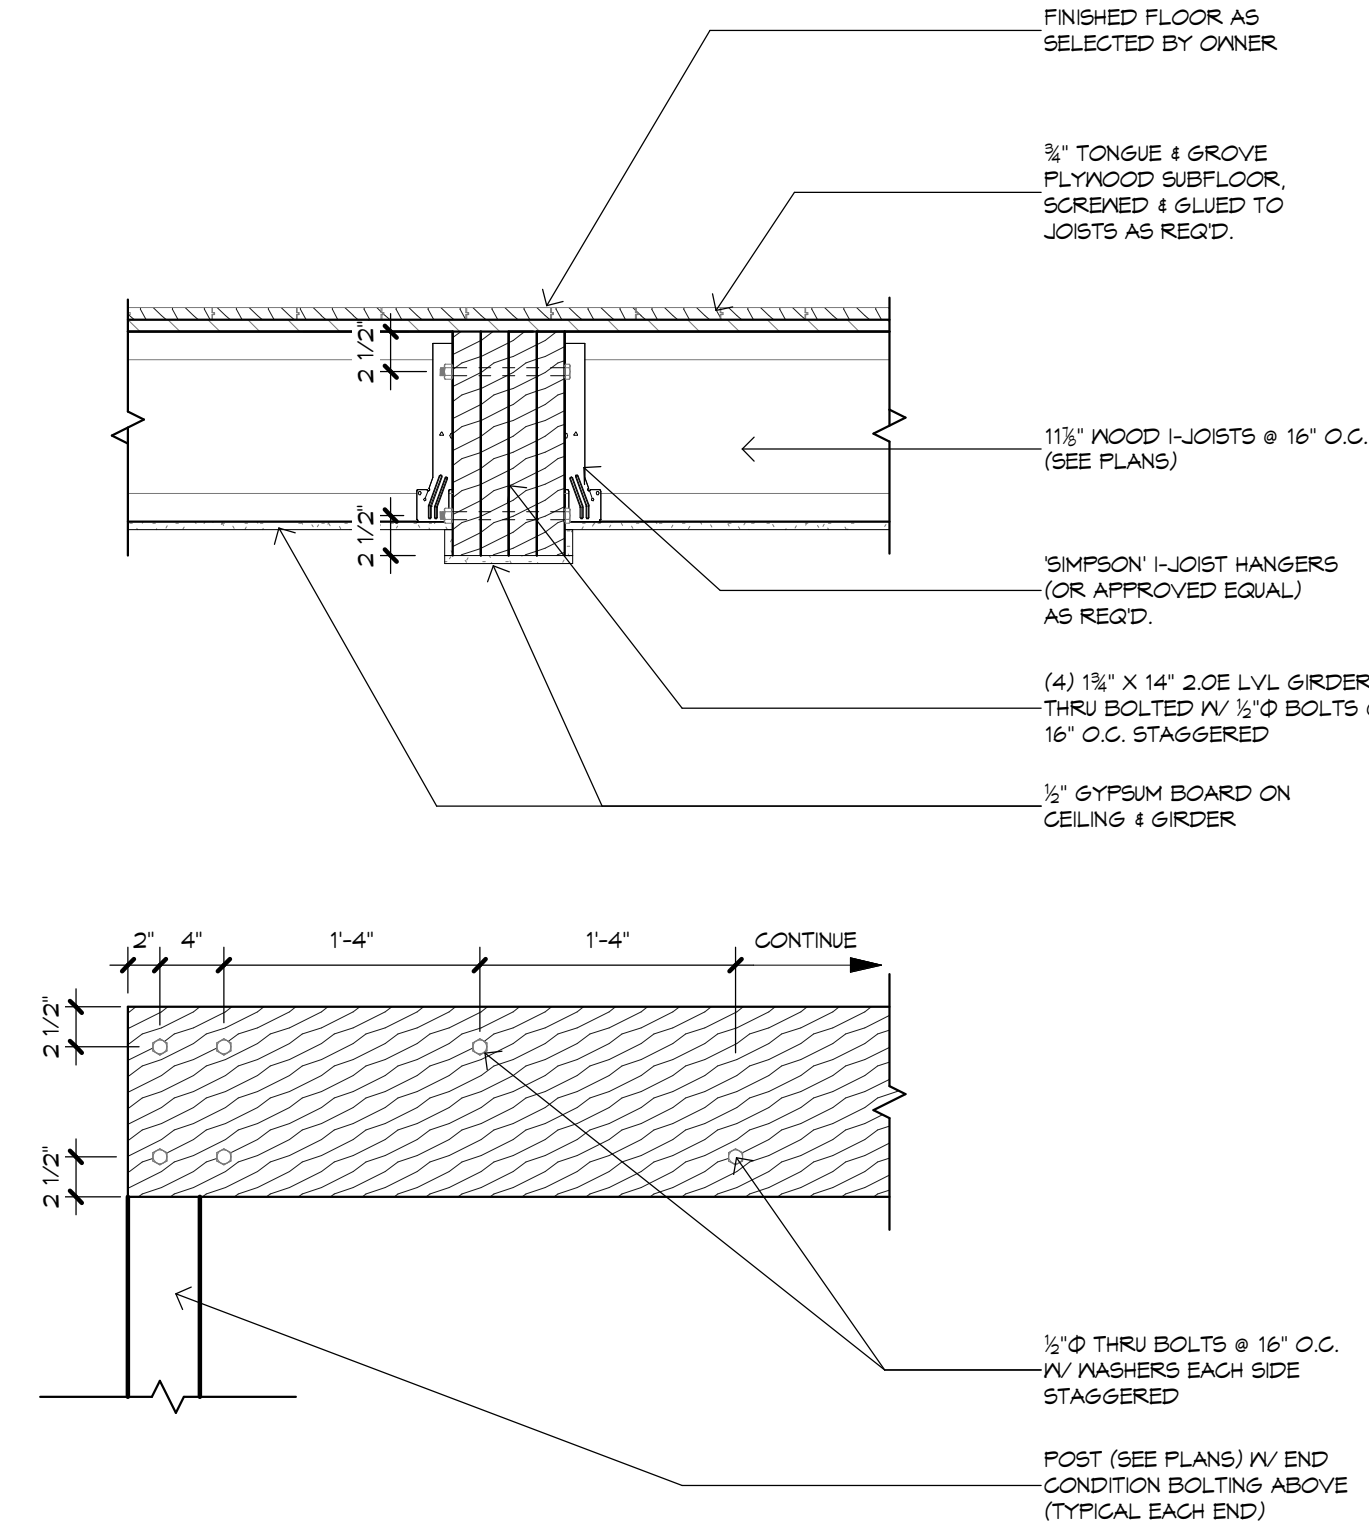


LVL BEAM DETAIL

SCALE: 1" = 1'-0"

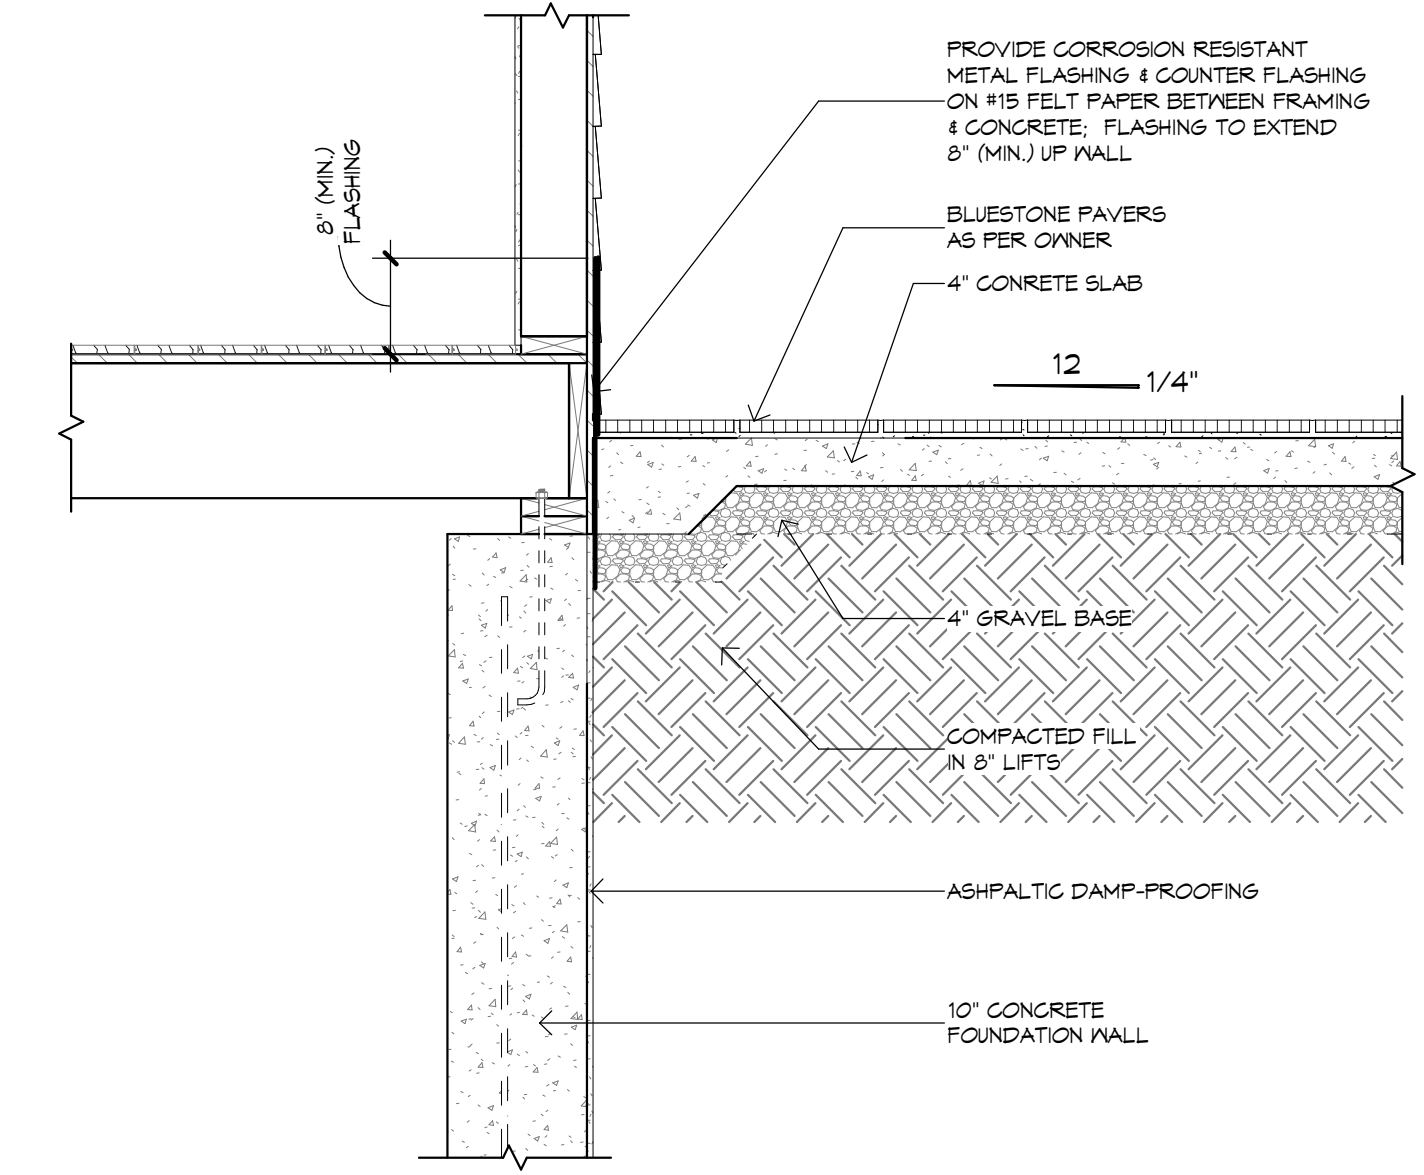


PORCH DETAIL


SCALE: 3/4" = 1'-0"

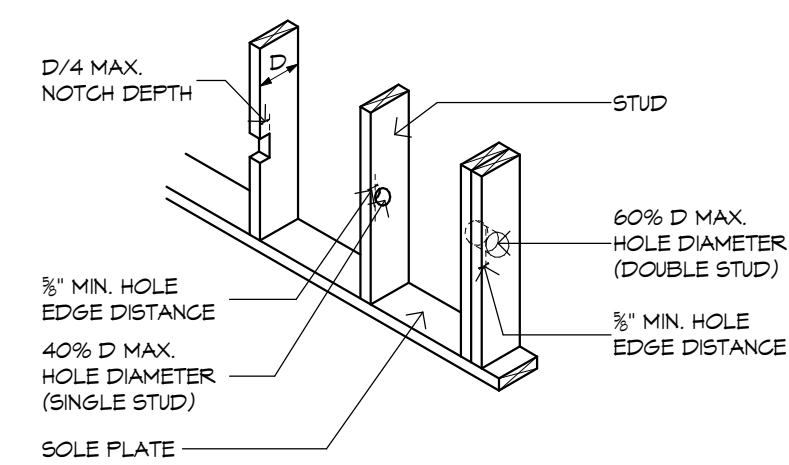


STUD - NOTCHING & DRILLING

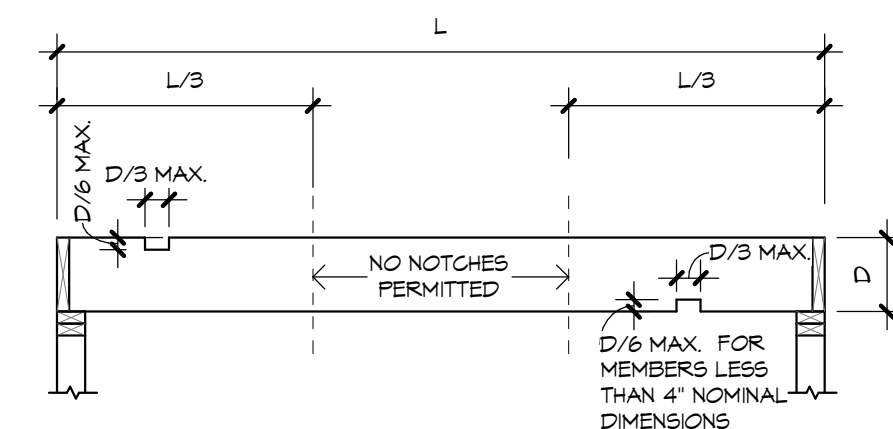


FLOOR JOISTS - CENTER CUTS

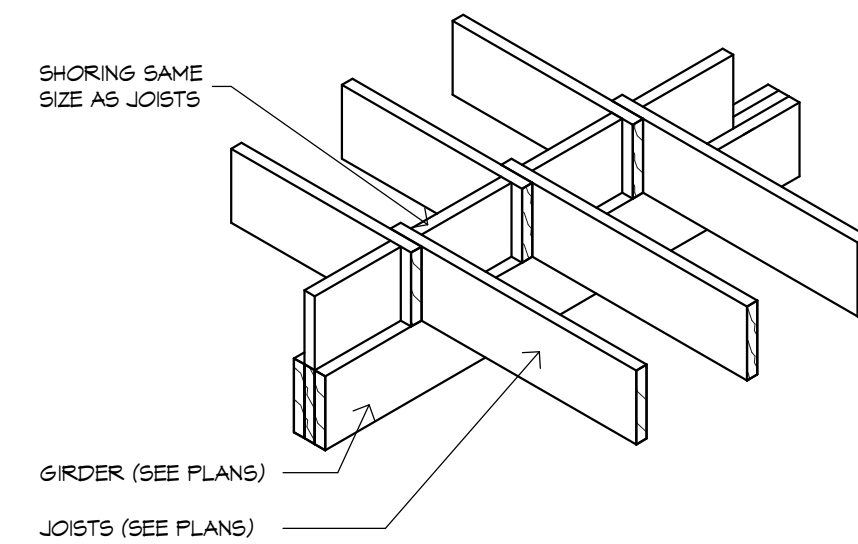


FLOOR JOISTS OVER GIRDER

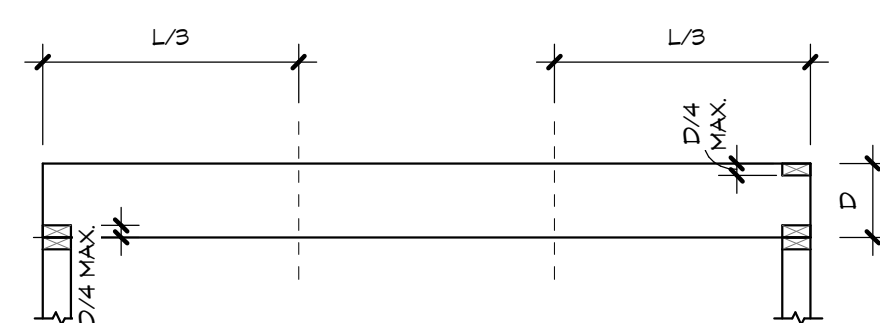


FLOOR JOISTS - END CUTS

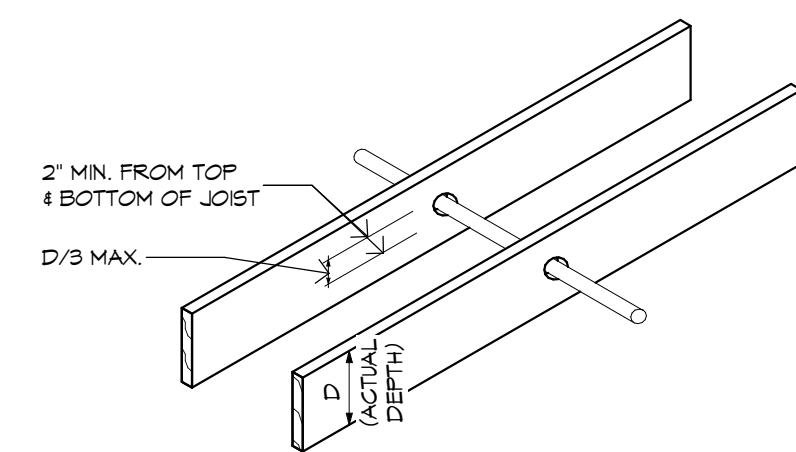

FLOOR JOISTS - DRILLING

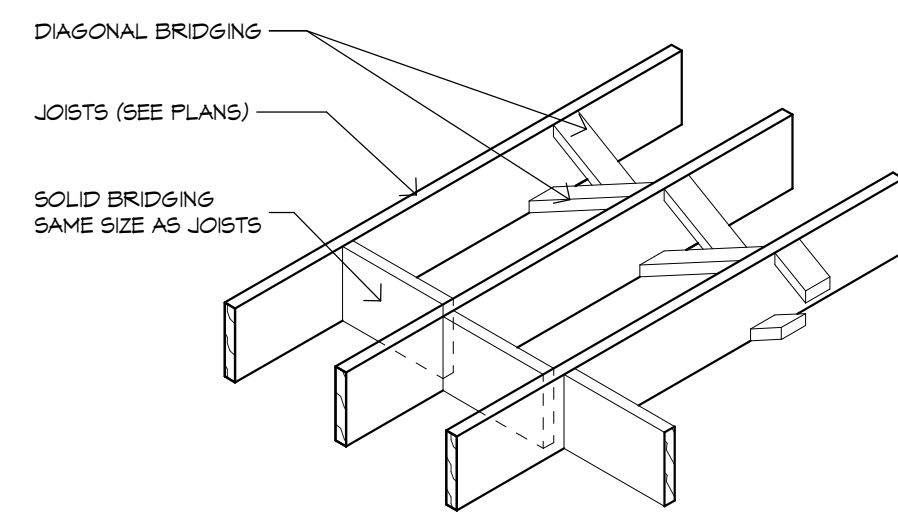


BRIDGING OPTIONS OF JOISTS

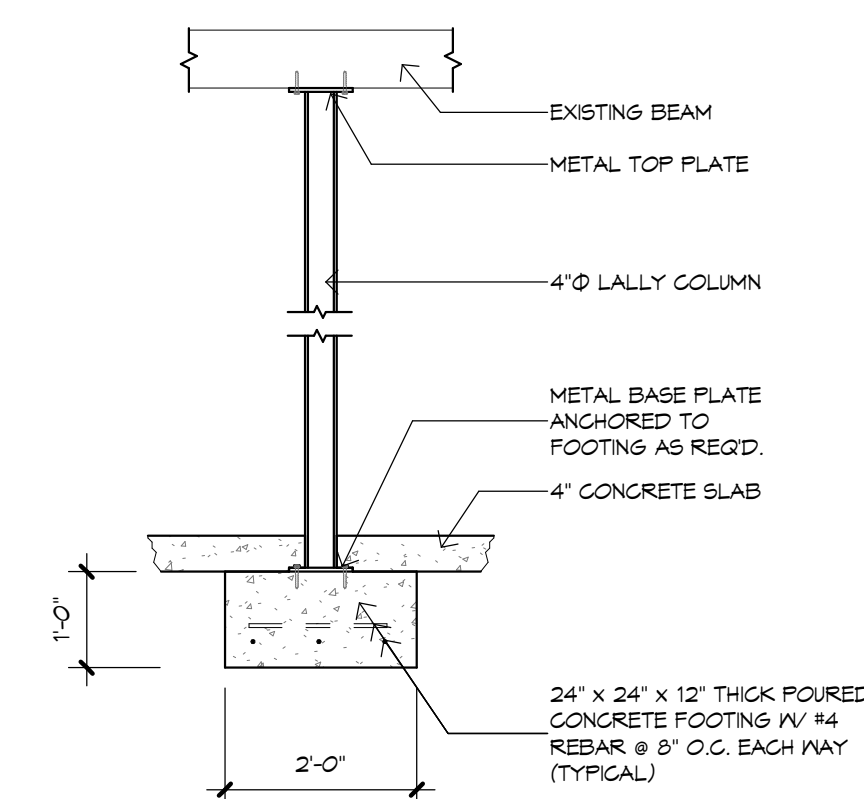

LALLY COLUMN DETAIL

SCALE: 1/2" = 1'-0"

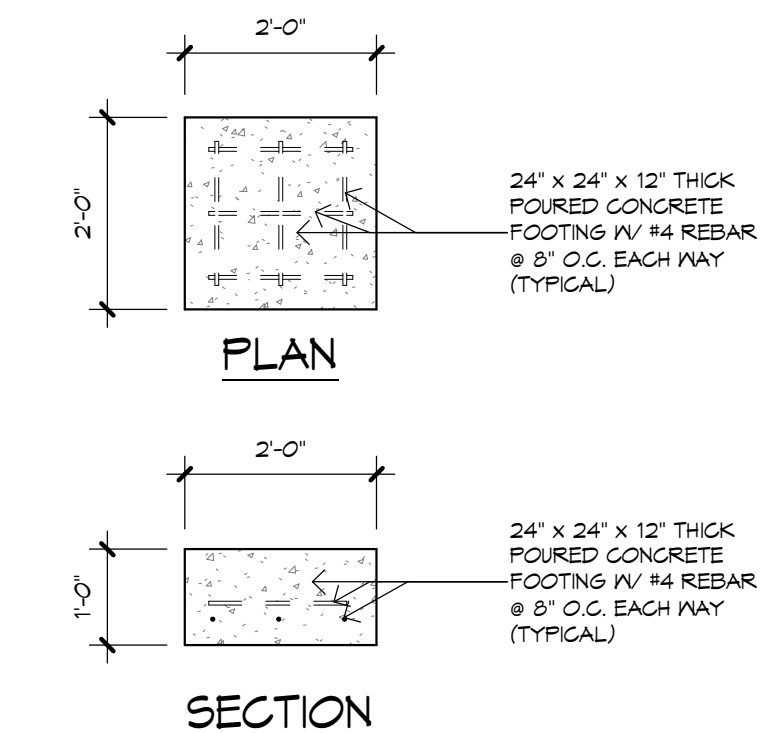

FOOTING SECTION

SCALE: 1/2" = 1'-0"

DIMENSIONAL FRAMING DETAILS

SCALE: 1/2" = 1'-0"

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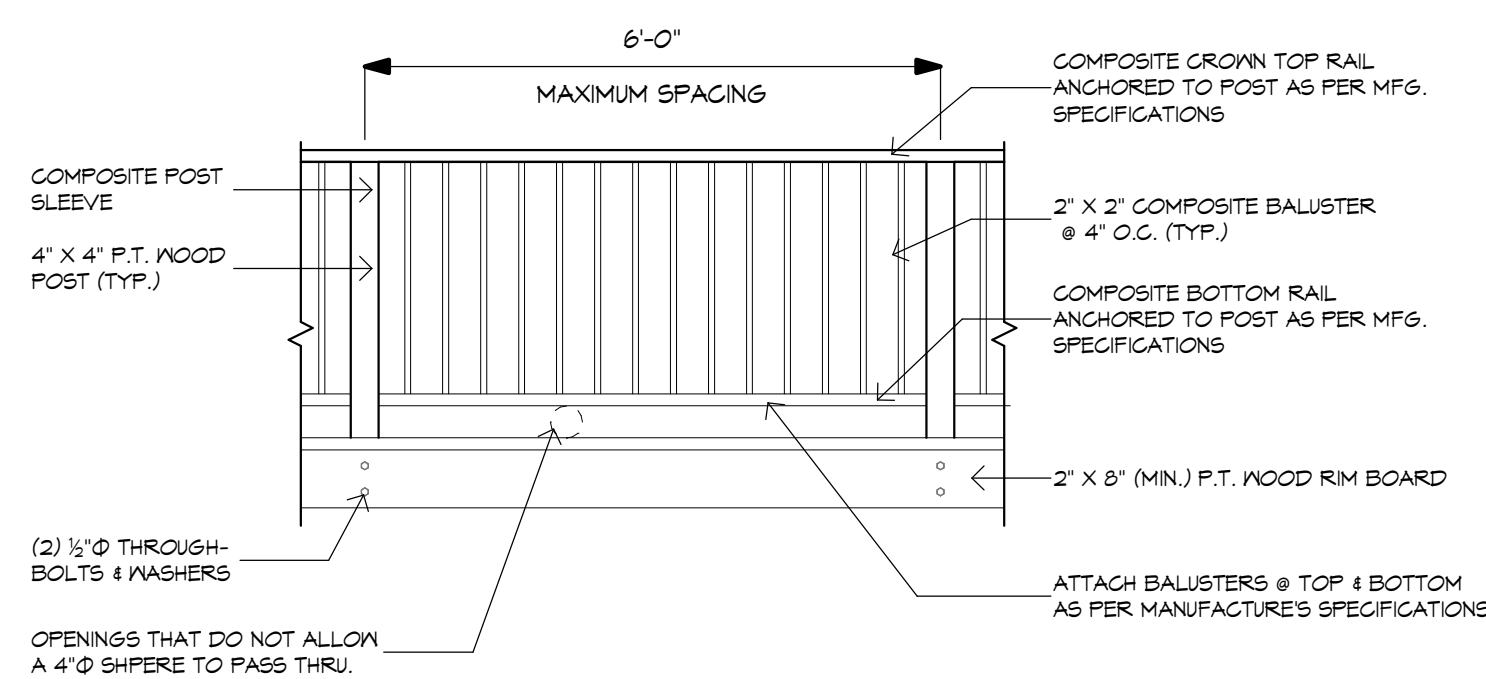
REVISIONS

Number	Date	Description


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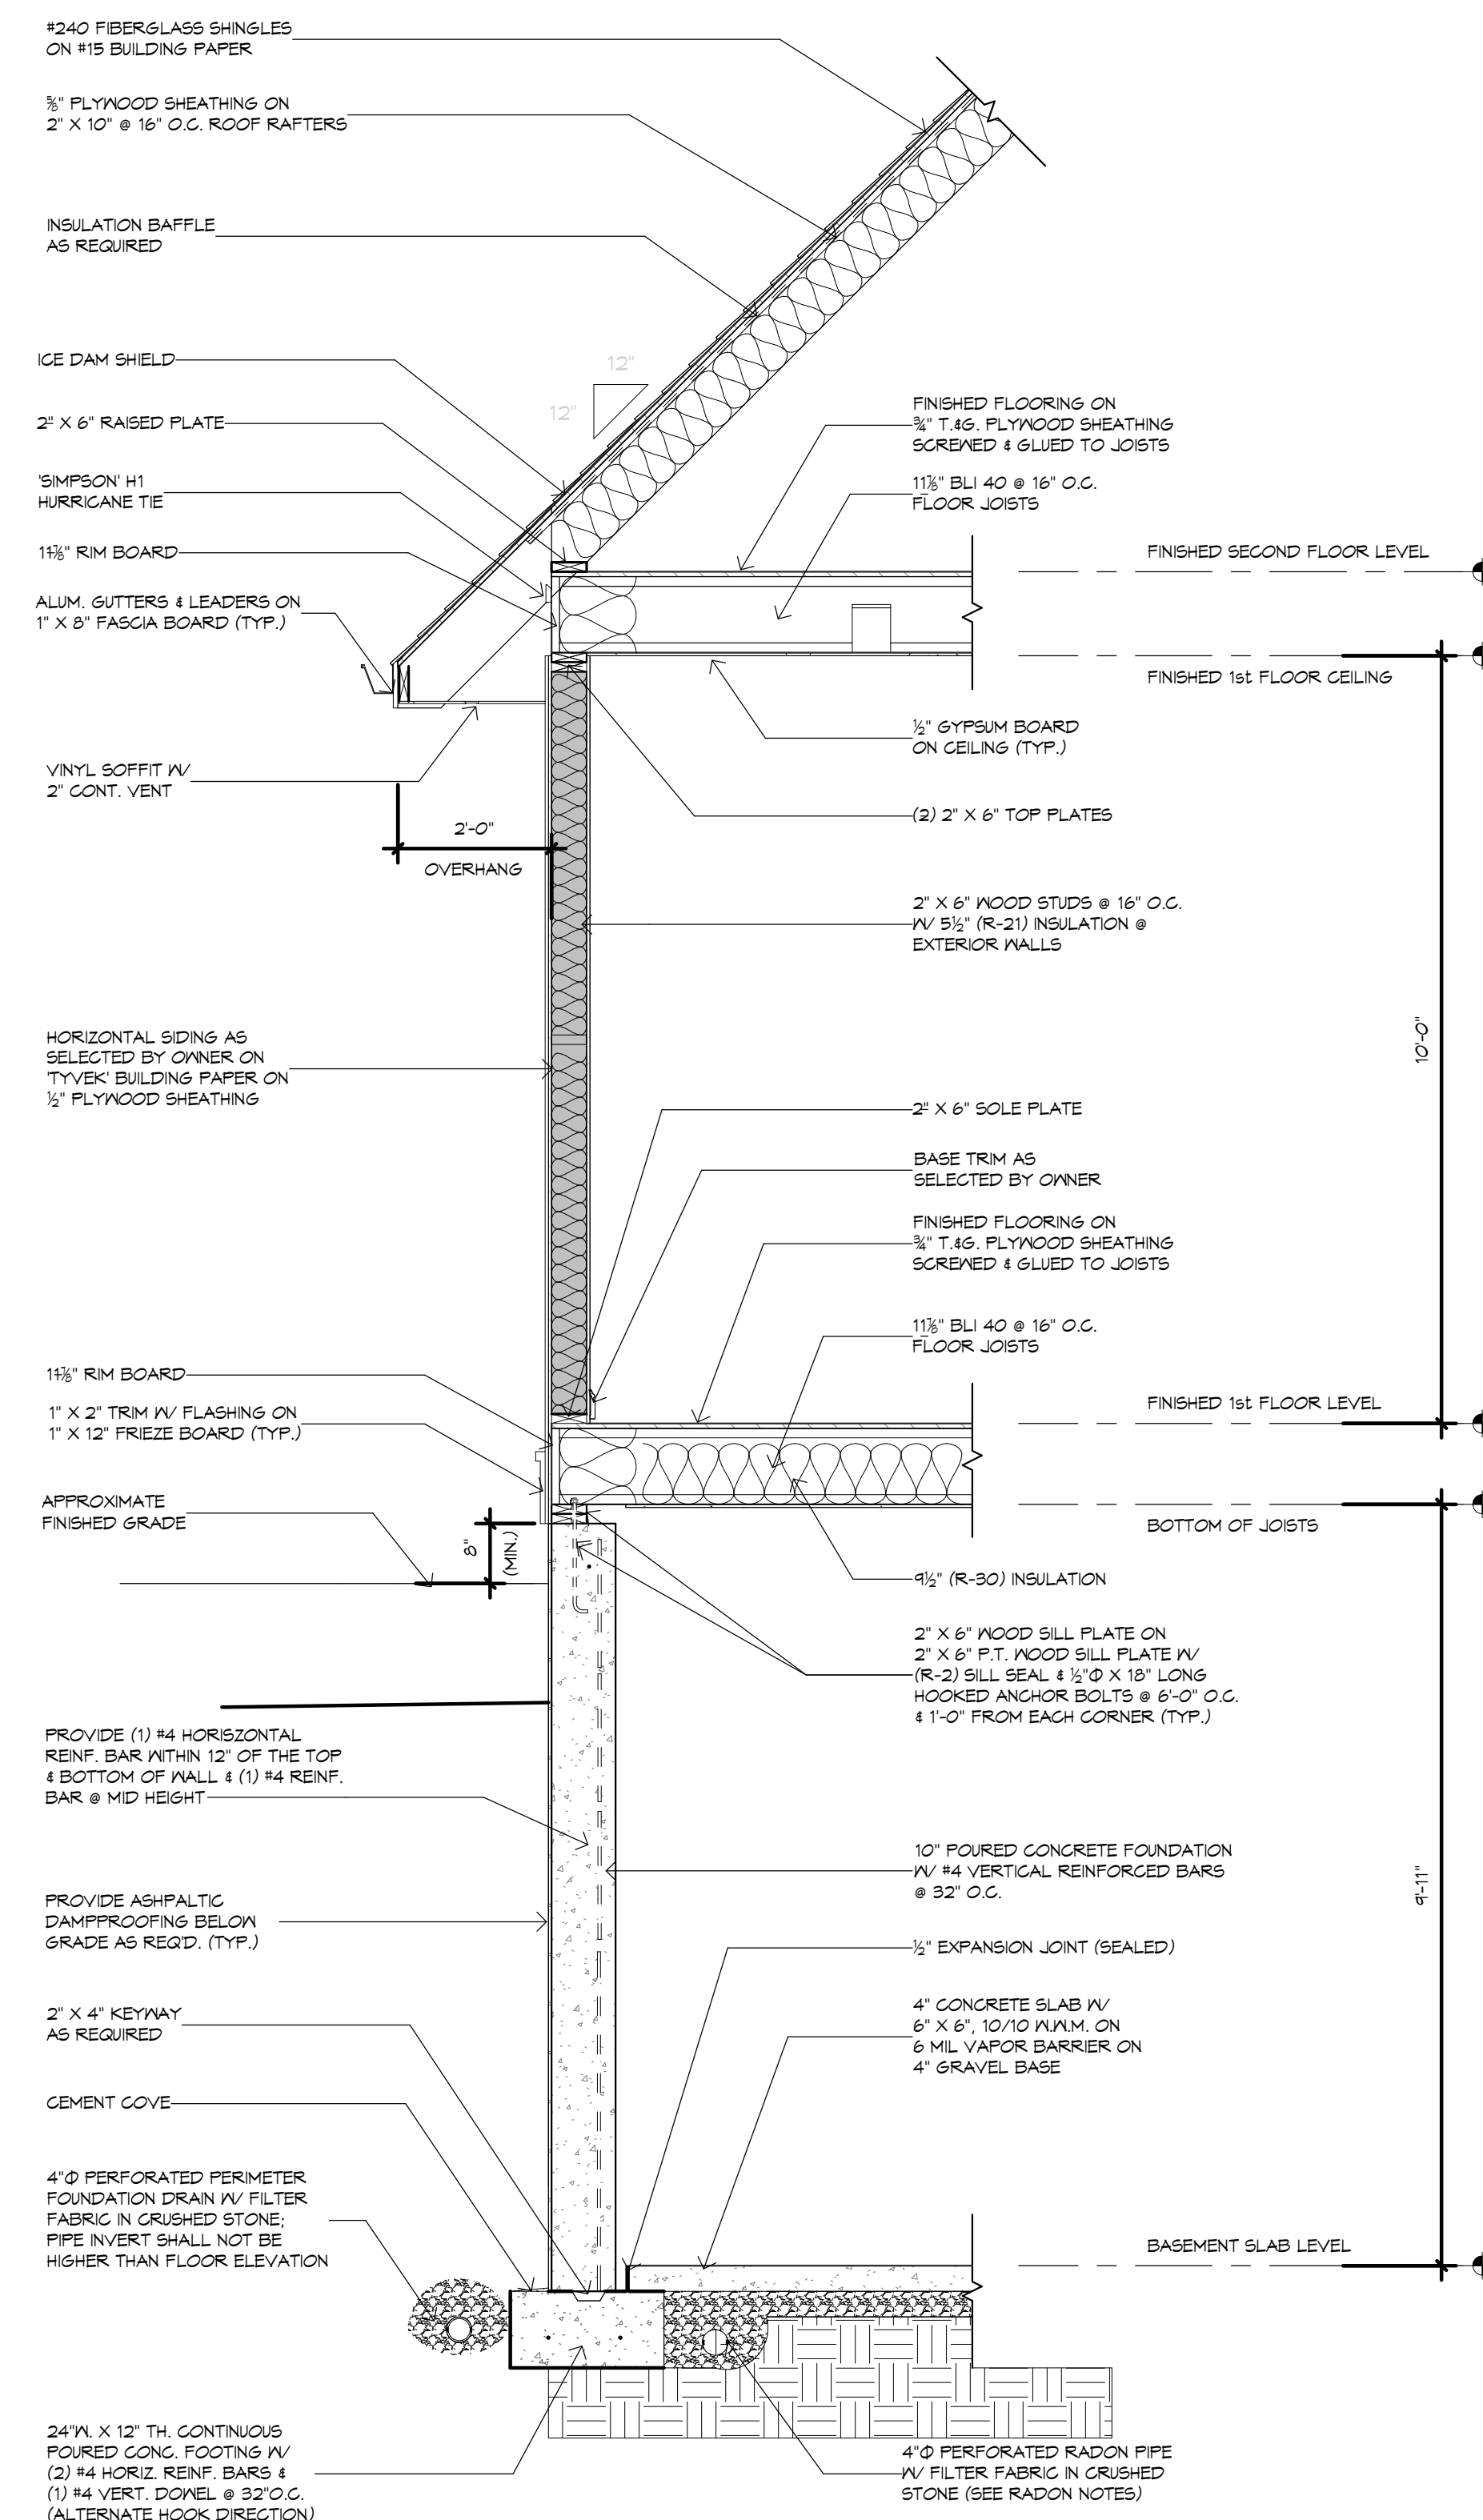
BABULA ARCHITECTURE LLC
Fine Hill Farms Development LLC
MODEL-B
MILFORD, PA 18337
Drawn By: JB
Job No: 22-095
Date: 5-15-24
Sheet No: 10 of 12
Sheet: A4.0



DECK GUARDRAIL DETAIL
SCALE: 1/2" = 1'-0"



RAKE & EAVE DETAIL
SCALE: 1/8" = 1'-0"

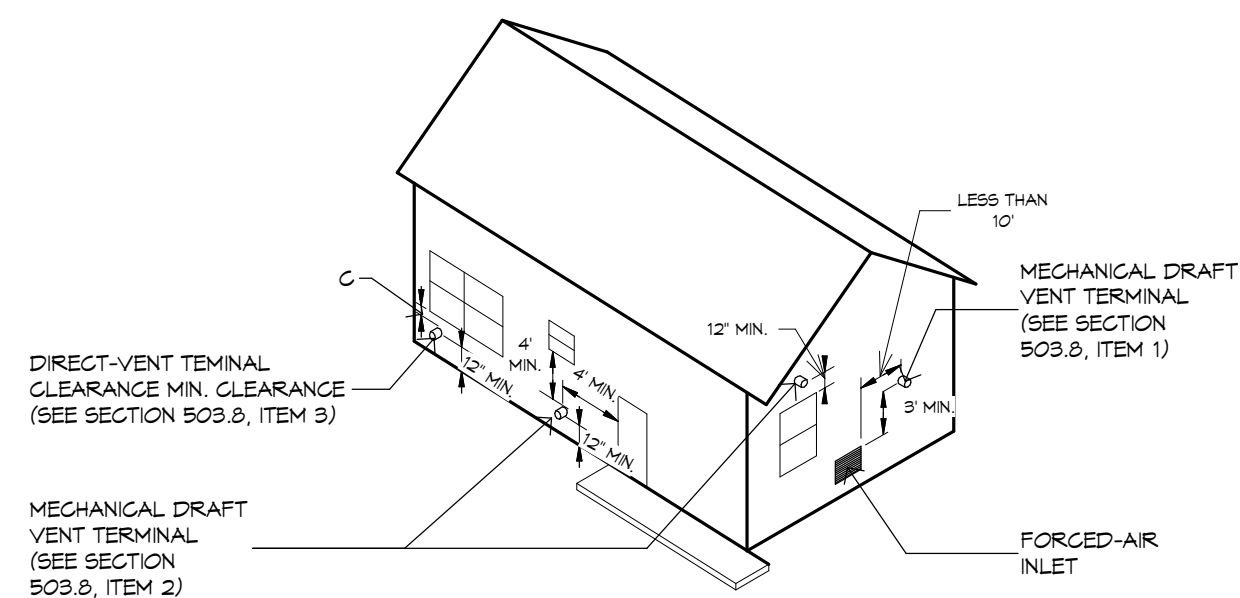

TYPICAL WALL SECTION
SCALE: 1/2" = 1'-0"

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REVISIONS	
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Sheet No: 11 of 12
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